

Appendix 9: Earthworks, Retaining Walls and Drainage Design

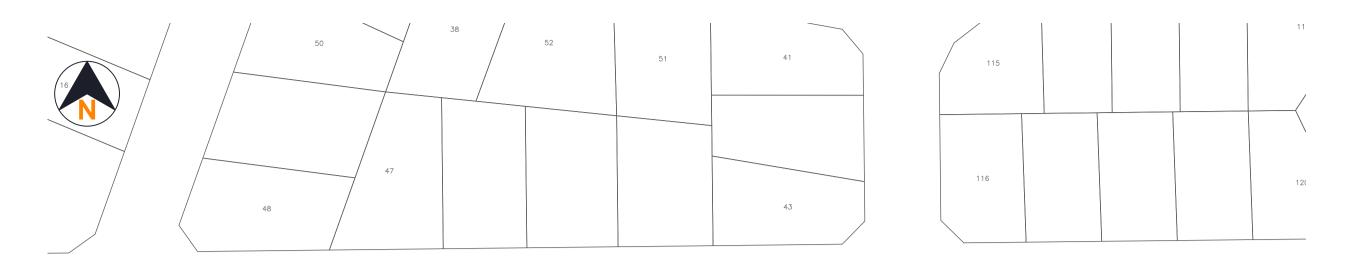

HAYWARD STREET

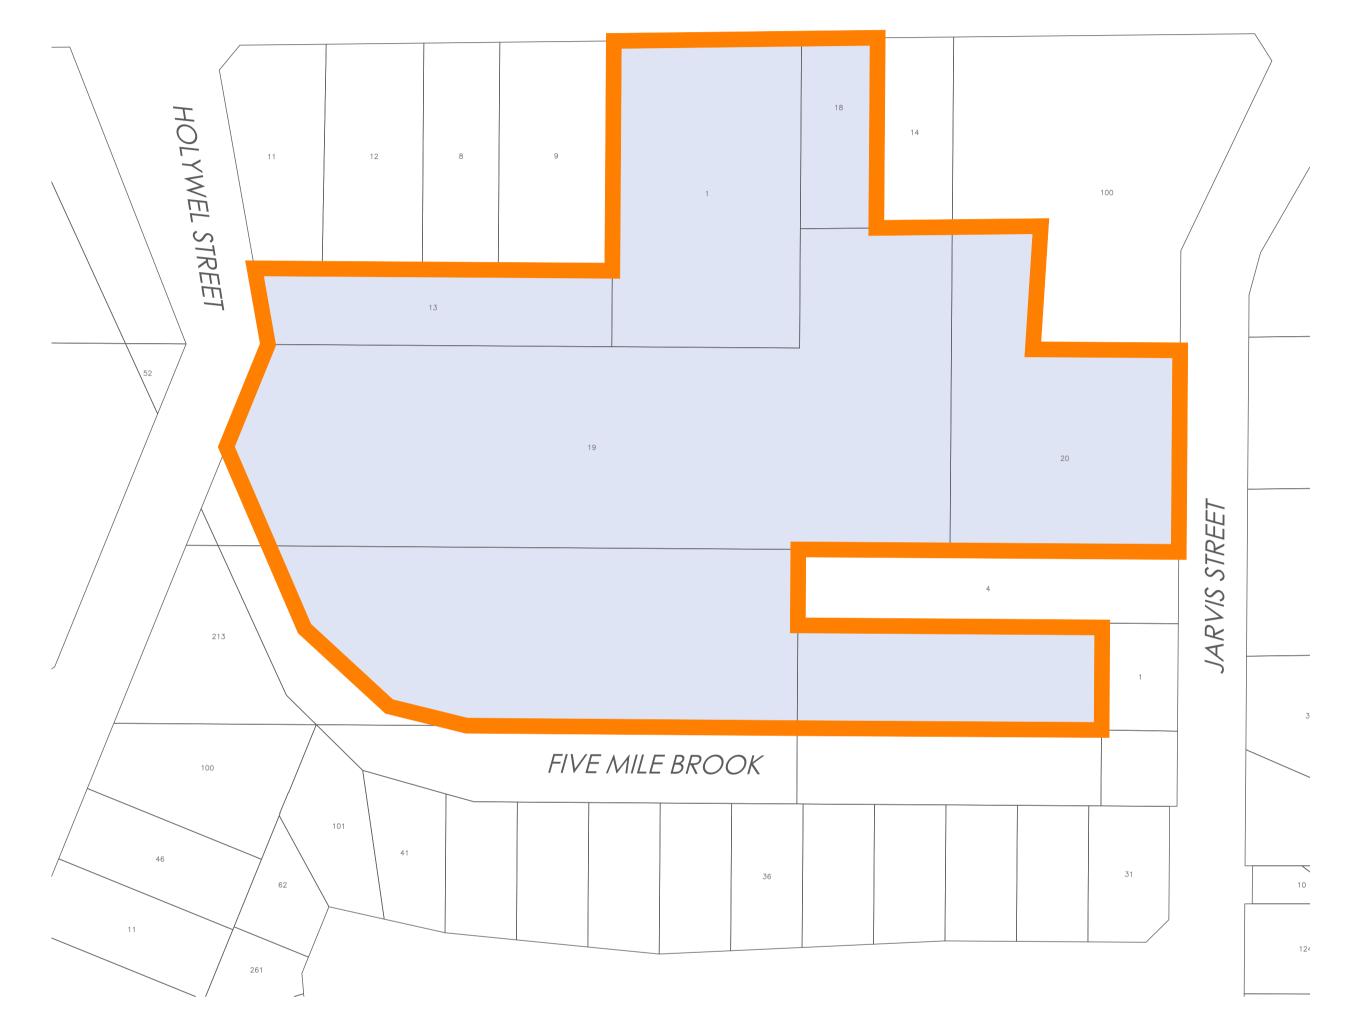

DRAWING LIST

DESIGN DRAWINGS

2511-01-330

2511-01-331

2511-01-000	COVER SHEET	2511-01-400	DRAINAGE PLAN DRAINAGE LONGITUDINAL SECTIONS - SHEET 1
2511-01-001	EXISTING CONDITIONS PLAN	2511-01-411	DRAINAGE LONGITUDINAL SECTIONS - SHEET 2
2511-01-030	GENERAL ARRANGEMENT PLAN	2511-01-412 2511-01-420 2511-01-430	DRAINAGE LONGITUDINAL SECTIONS - SHEET 3 DRAINAGE CATCHMENT PLAN DRAINAGE CALCULATIONS
2511-01-100 2511-01-101 2511-01-102	FINISHED SURFACE EARTHWORKS PLAN SUBGRADE SURFACE EARTHWORKS PLAN TYPICAL EARTHWORKS DETAILS	2511-01-450 2511-01-451	DRAINAGE BASIN LAYOUT PLAN - SHEET 1 DRAINAGE BASIN LAYOUT PLAN - SHEET 2
2511-01-110 2511-01-111 2511-01-112 2511-01-113	EARTHWORKS CROSS SECTIONS - SHEET 1 EARTHWORKS CROSS SECTIONS - SHEET 2 EARTHWORKS CROSS SECTIONS - SHEET 3 EARTHWORKS CROSS SECTIONS - SHEET 4	2511-01-600 2511-01-640 2511-01-641 2511-01-642	SHARED PATH LAYOUT PLAN AND LONGITUDINAL SECTION SHARED PATH CROSS SECTIONS - SHEET 1 SHARED PATH CROSS SECTIONS - SHEET 2 SHARED PATH CROSS SECTIONS - SHEET 3
2511-01-150	RETAINING WALL PLAN	STANDARD DRA	WINGS
2511-01-155 2511-01-156 2511-01-157	RETAINING WALL LONGITUDINAL SECTIONS - SHEET 1 RETAINING WALL LONGITUDINAL SECTIONS - SHEET 2 RETAINING WALL LONGITUDINAL SECTIONS - SHEET 3	2511-STD-R1 2511-STD-R2	STANDARD DETAILS - ROADWORKS - SHEET 1 STANDARD DETAILS - ROADWORKS - SHEET 2
2511-01-300 2511-01-301 2511-01-310 2511-01-311 2511-01-320 2511-01-321	ROADWORKS LAYOUT PLAN - HAYWARD STREET CARPARK ROADWORKS LAYOUT PLAN - JARVIS STREET CARPARK ROADWORKS LONGITUDINAL SECTIONS - SHEET 1 ROADWORKS LONGITUDINAL SECTIONS - SHEET 2 CIVIL GRADING PLAN - JARVIS STREET CARPARK	2511-STD-D1 2511-STD-D2 2511-STD-D3	STANDARD DETAILS - DRAINAGE - SHEET 1 STANDARD DETAILS - DRAINAGE - SHEET 2 STANDARD DETAILS - DRAINAGE - SHEET 3

SIGNAGE AND LINEMARKING PLAN - HAYWARD STREET CARPARK

SIGNAGE AND LINEMARKING PLAN - JARVIS STREET CARPARK



SOUTH BUNBURY COMMUNITY AGED CARE

11 HAYWARD STREET SOUTH BUNBURY, WA.
CITY OF BUNBURY

EARTHWORKS, RETAINING WALLS AND DRAINAGE


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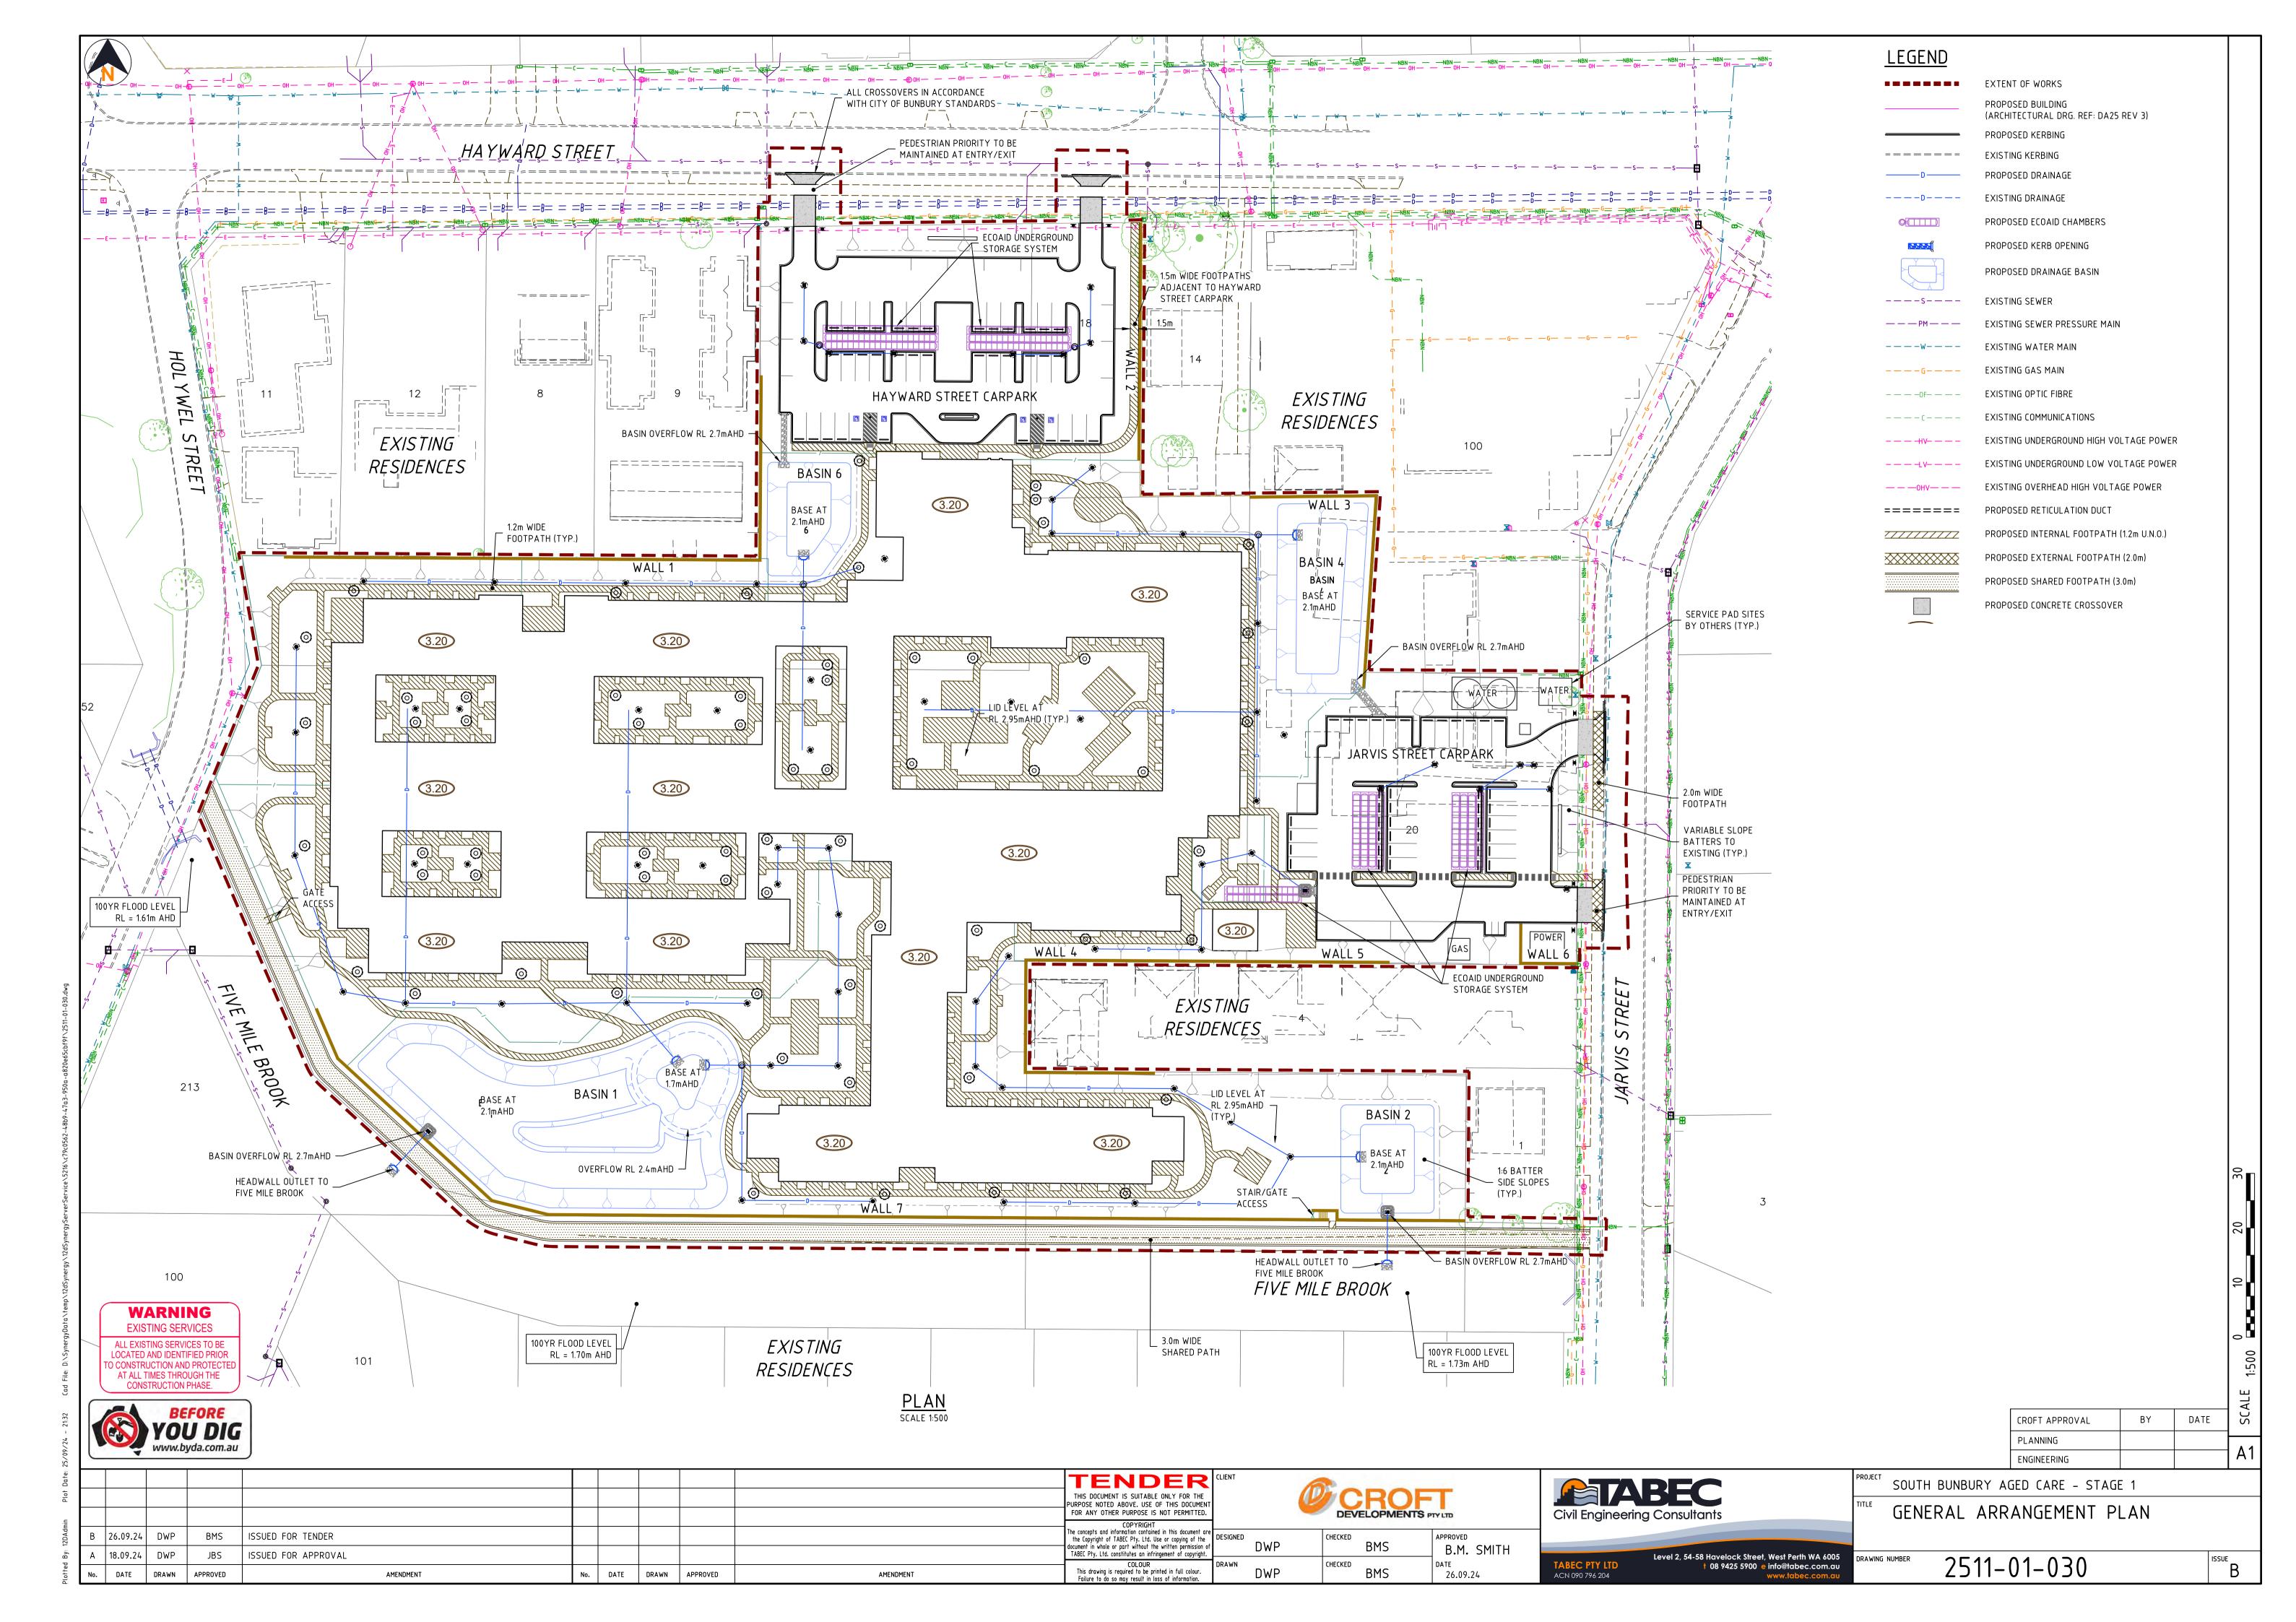
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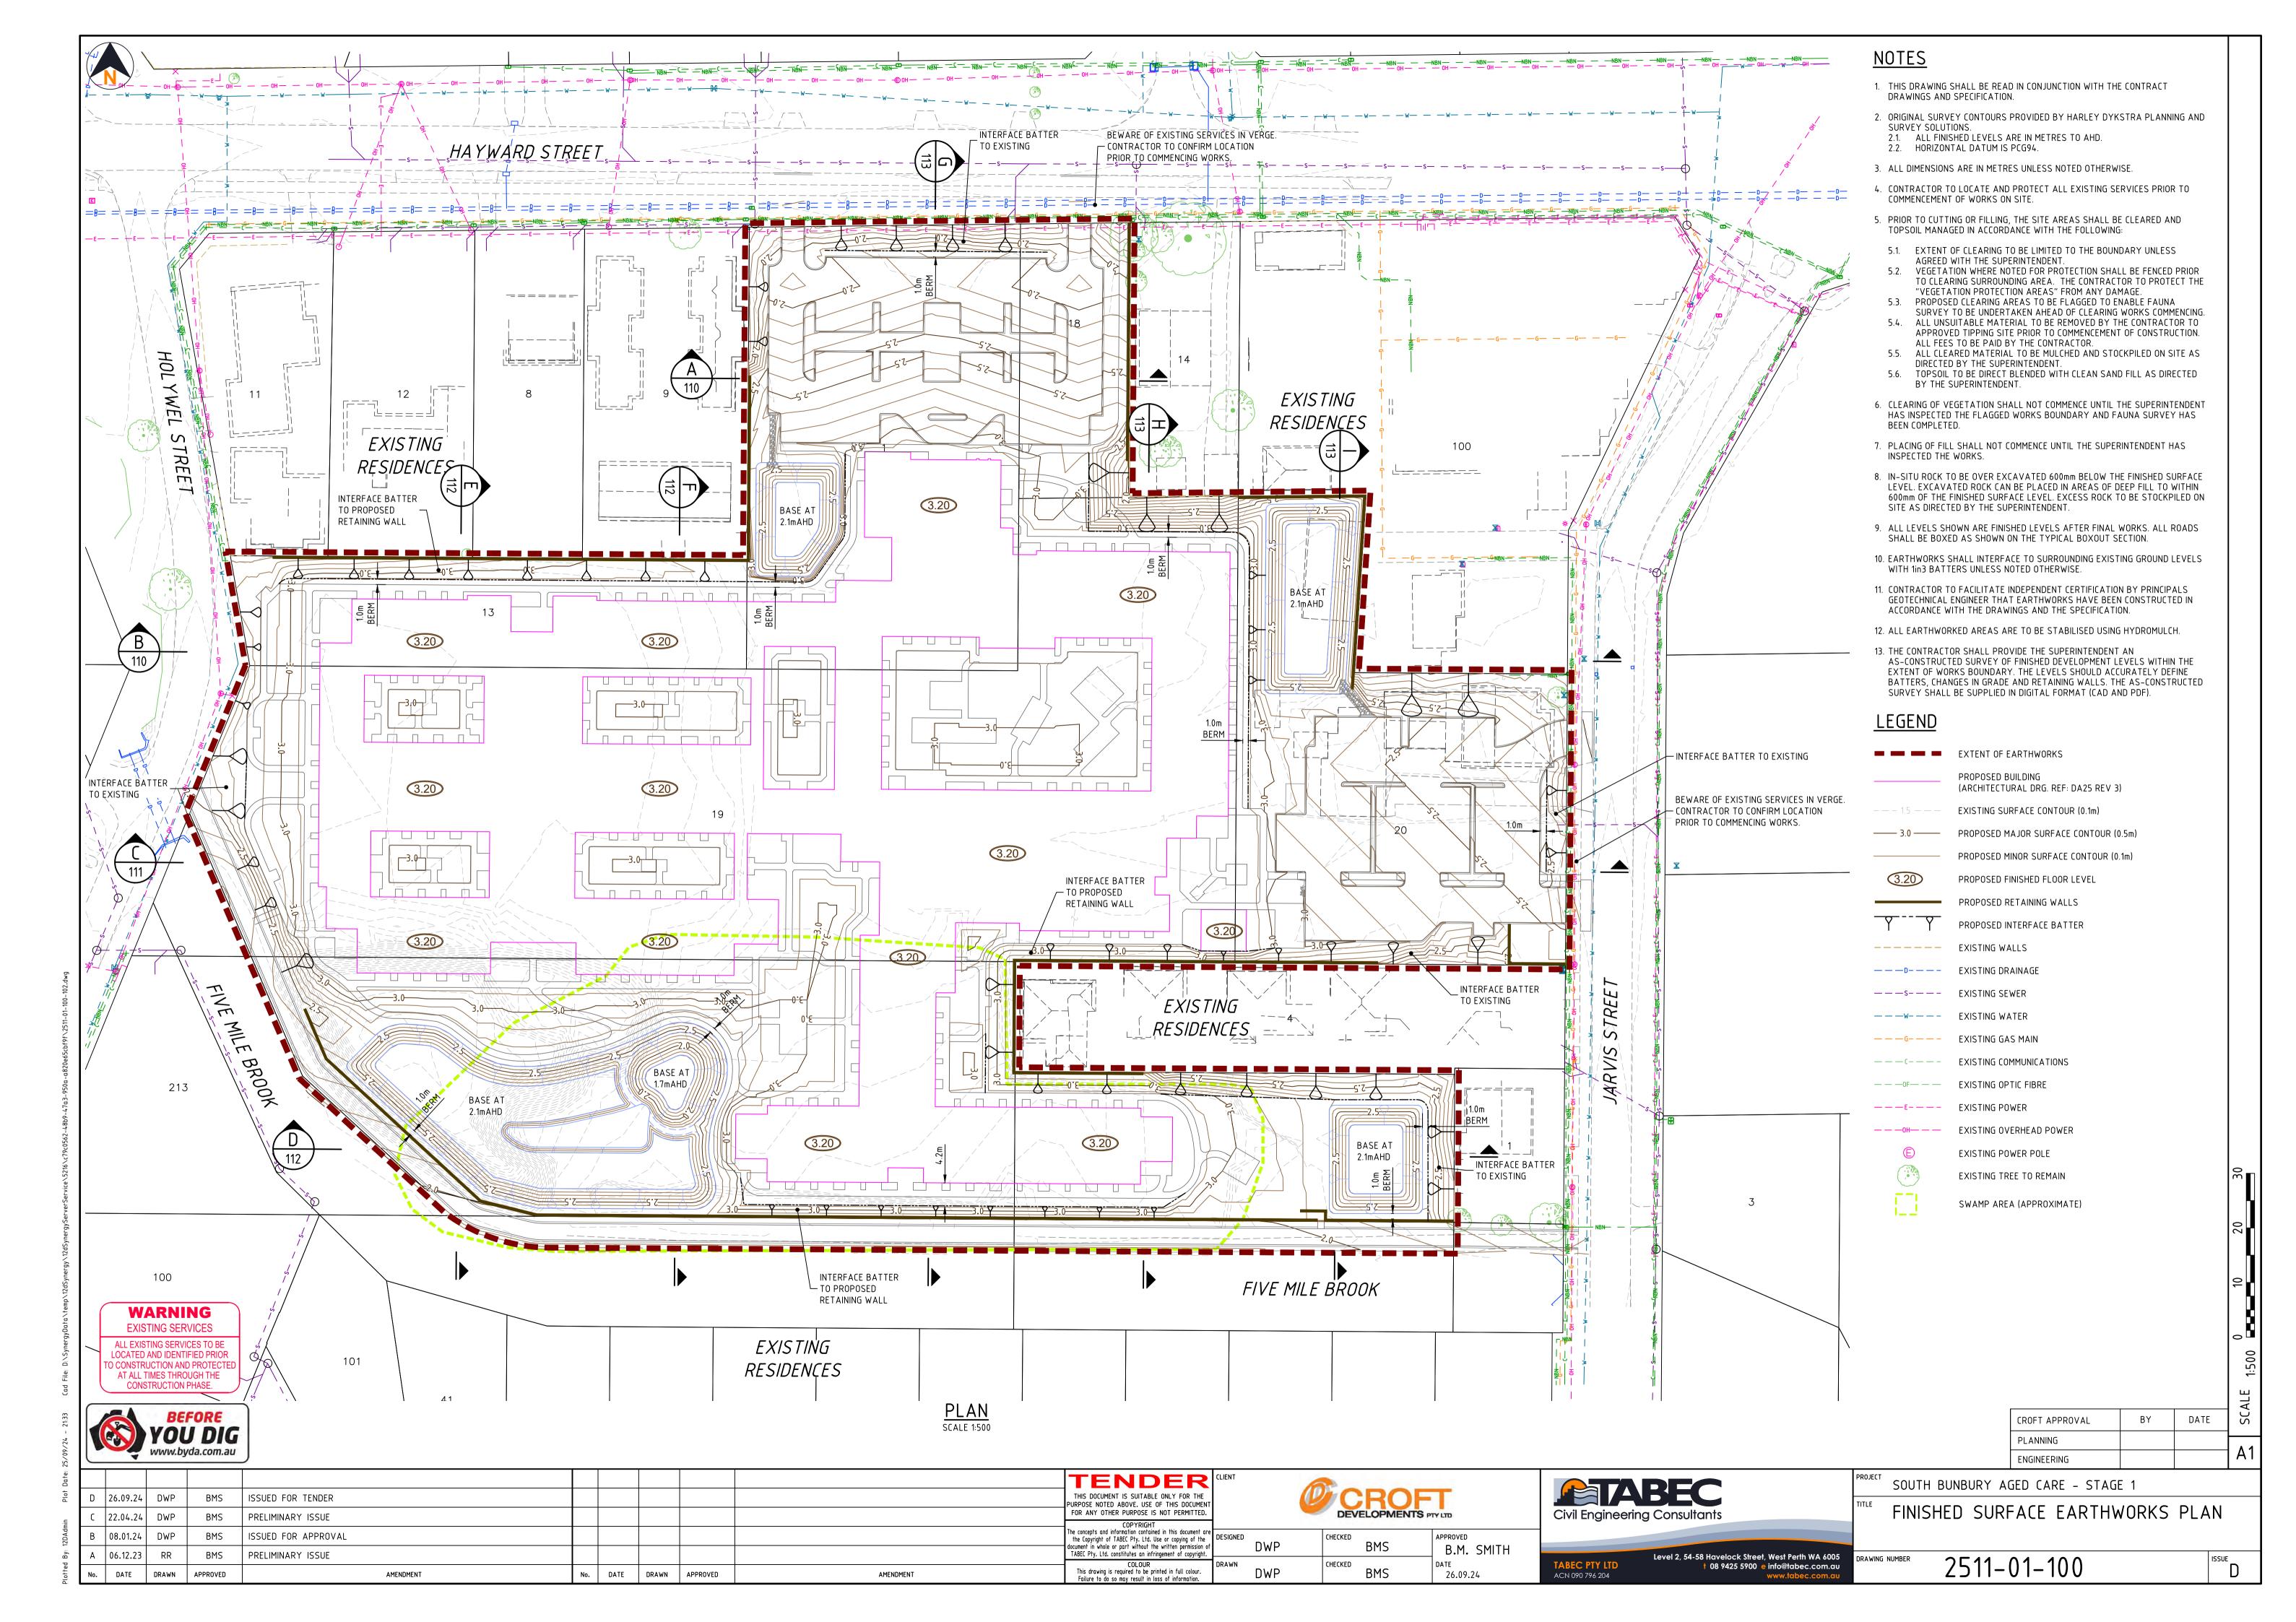
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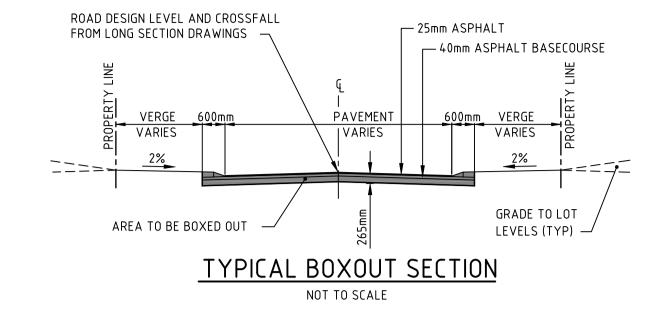
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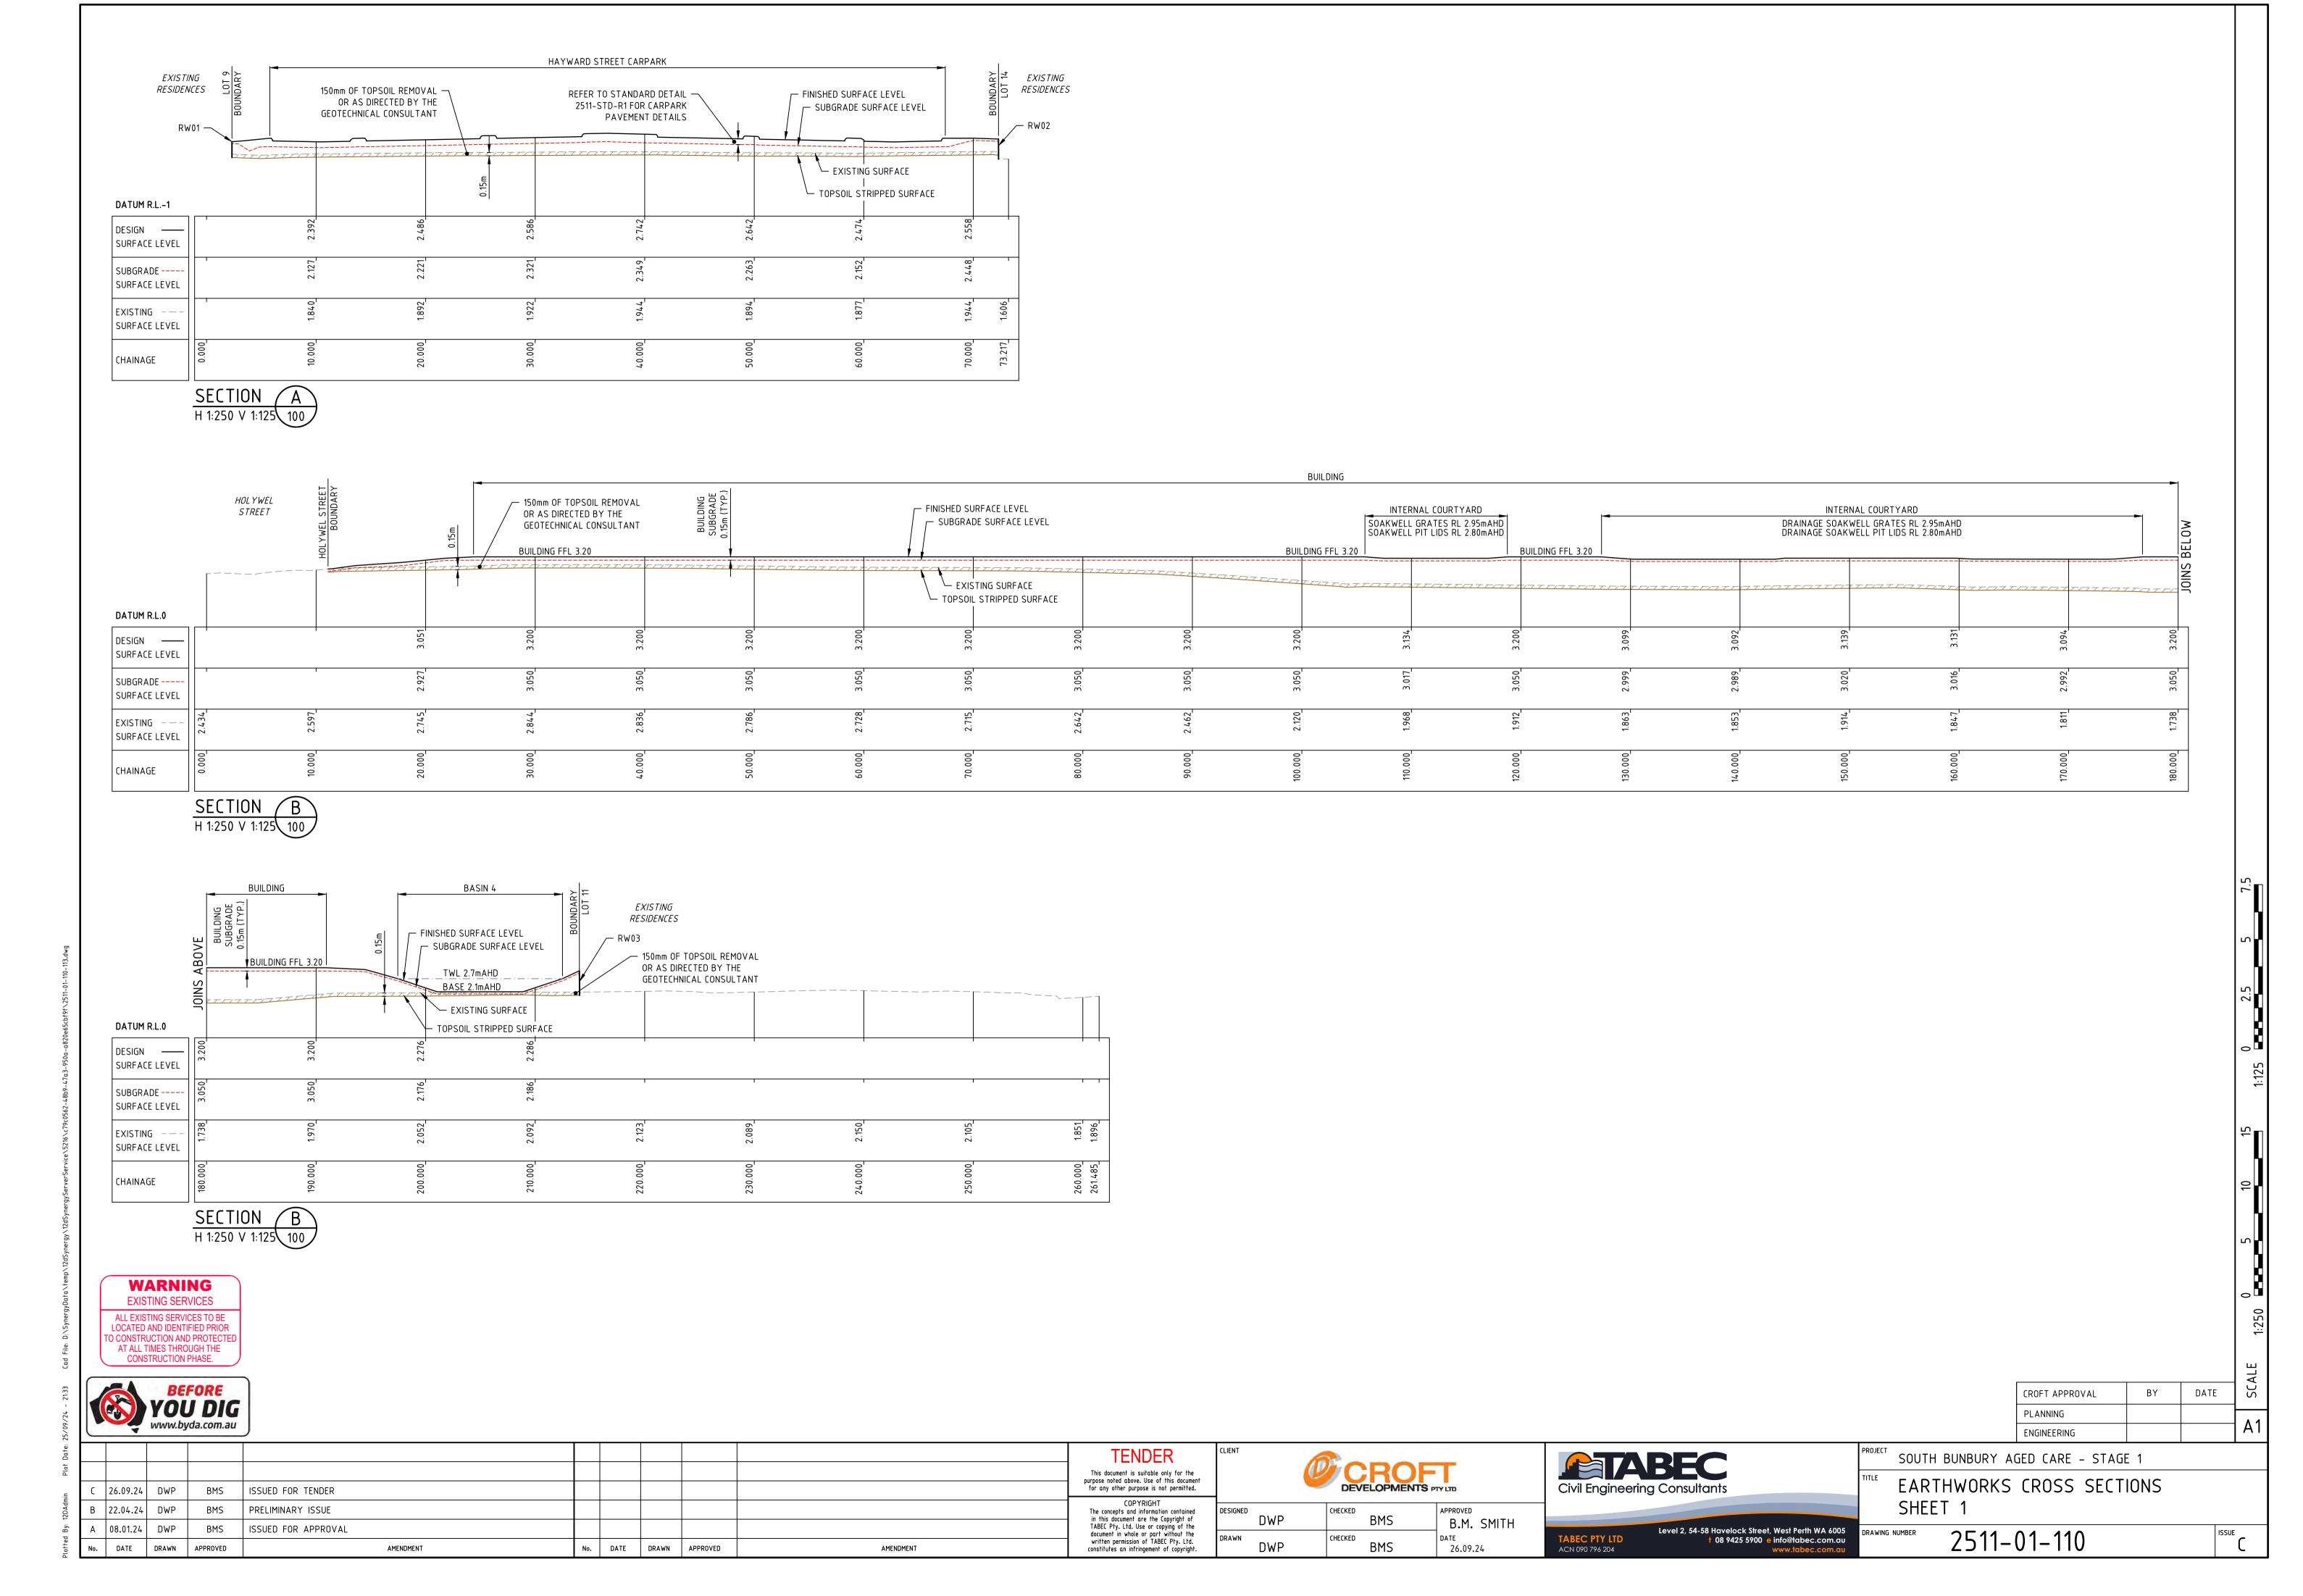
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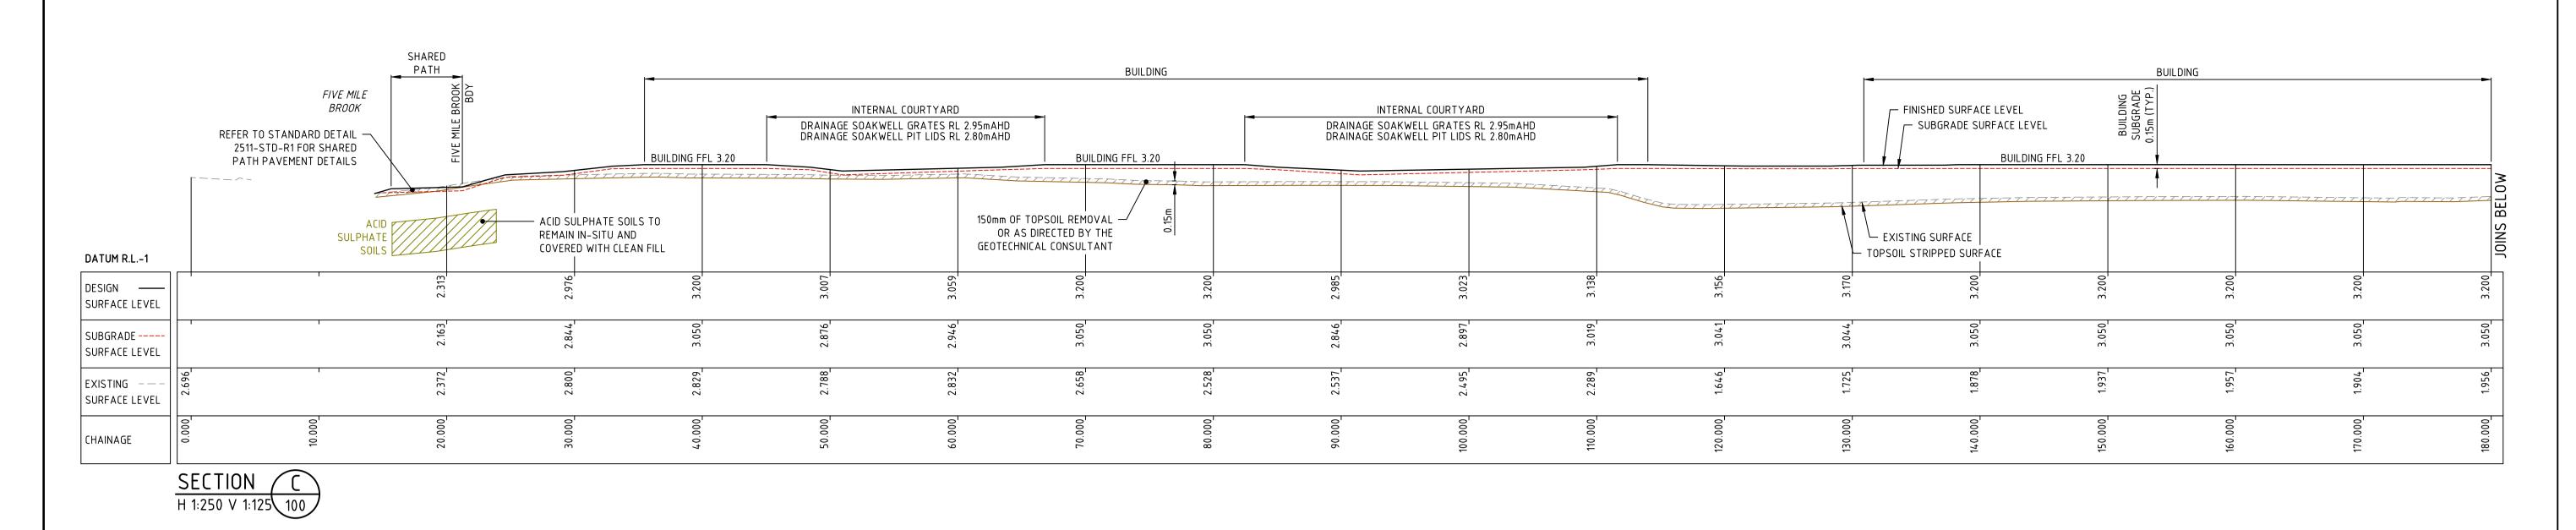
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PROJECT	SOUTH BUNBURY AGED CARE - STAGE 1
TITLE	TYPICAL EARTHWORKS DETAILS

A 6005 om.au om.au	DRAWING NUMBER	2511-01-102	ISSUE B





JARVIS STREET CARPARK BUILDING REFER TO STANDARD DETAIL — *JARVIS* 150mm OF TOPSOIL REMOVAL — 2511-STD-R1 FOR CARPARK STREET FINISHED SURFACE LEVEL OR AS DIRECTED BY THE PAVEMENT DETAILS SUBGRADE SURFACE LEVEL GEOTECHNICAL CONSULTANT BUILDING FFL 3.20 EXISTING SURFACE DATUM R.L.0 TOPSOIL STRIPPED SURFACE DESIGN —— SURFACE LEVEL SUBGRADE ----SURFACE LEVEL EXISTING -SURFACE LEVEL CHAINAGE
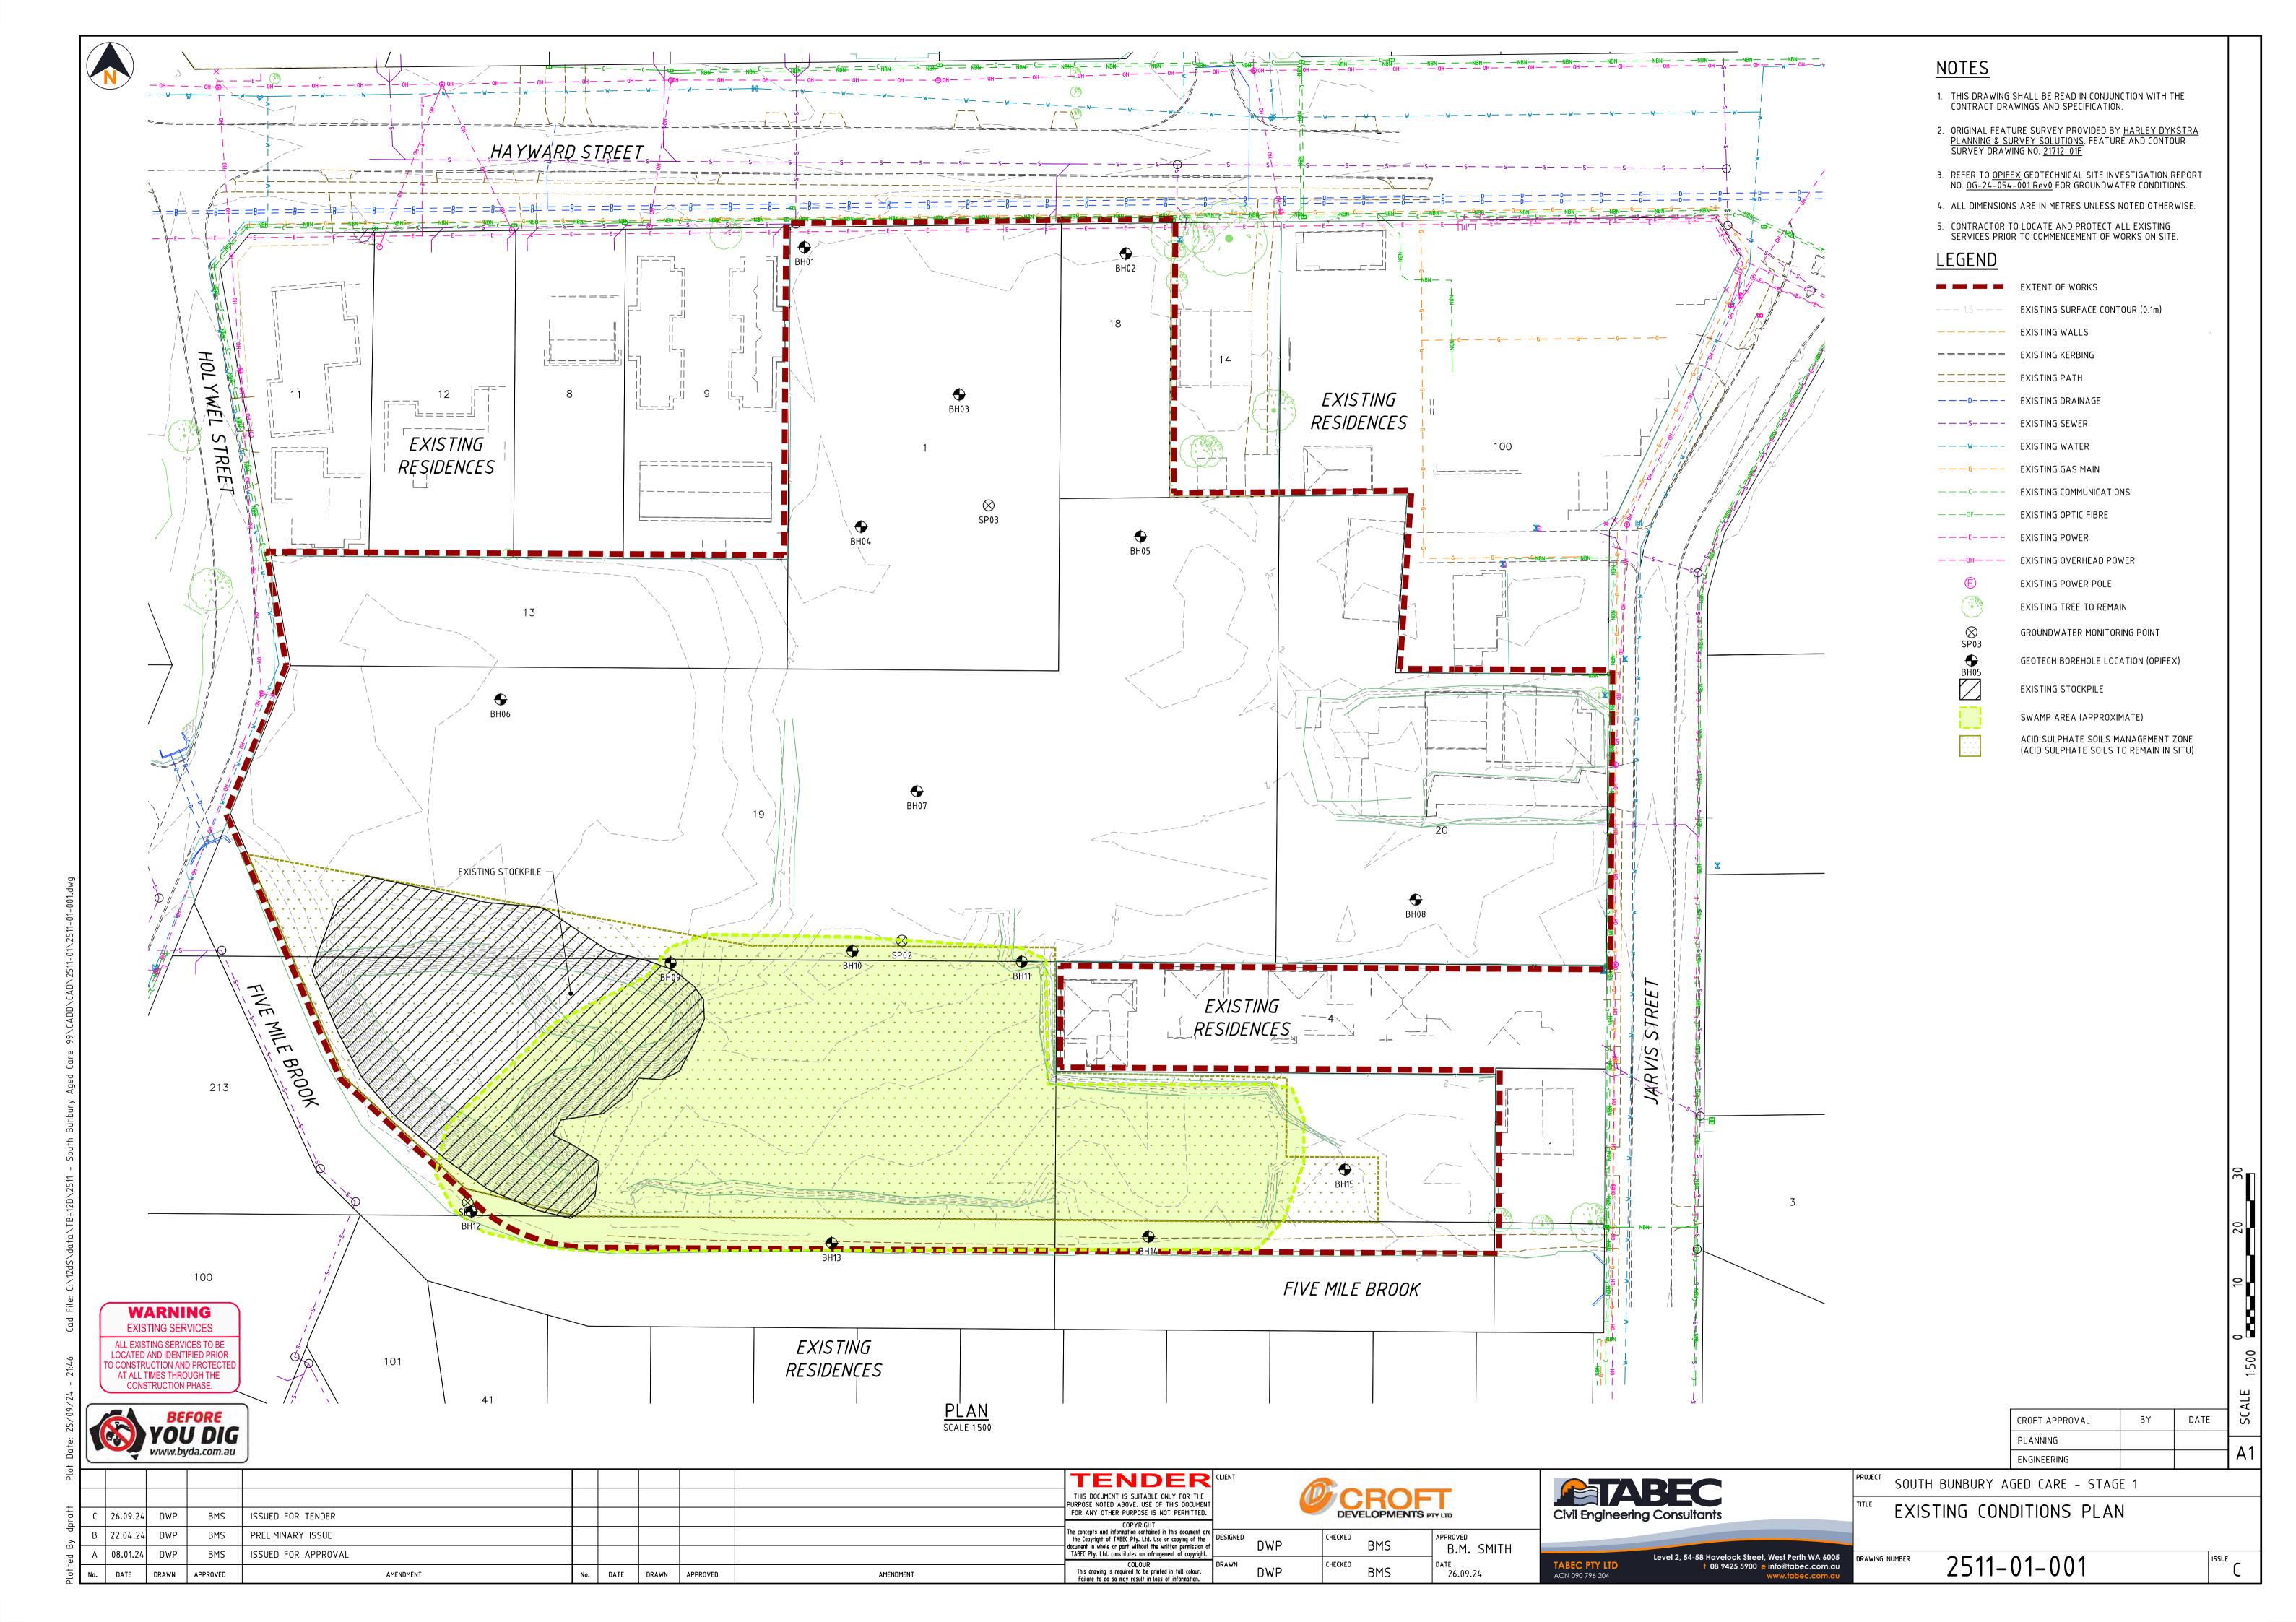
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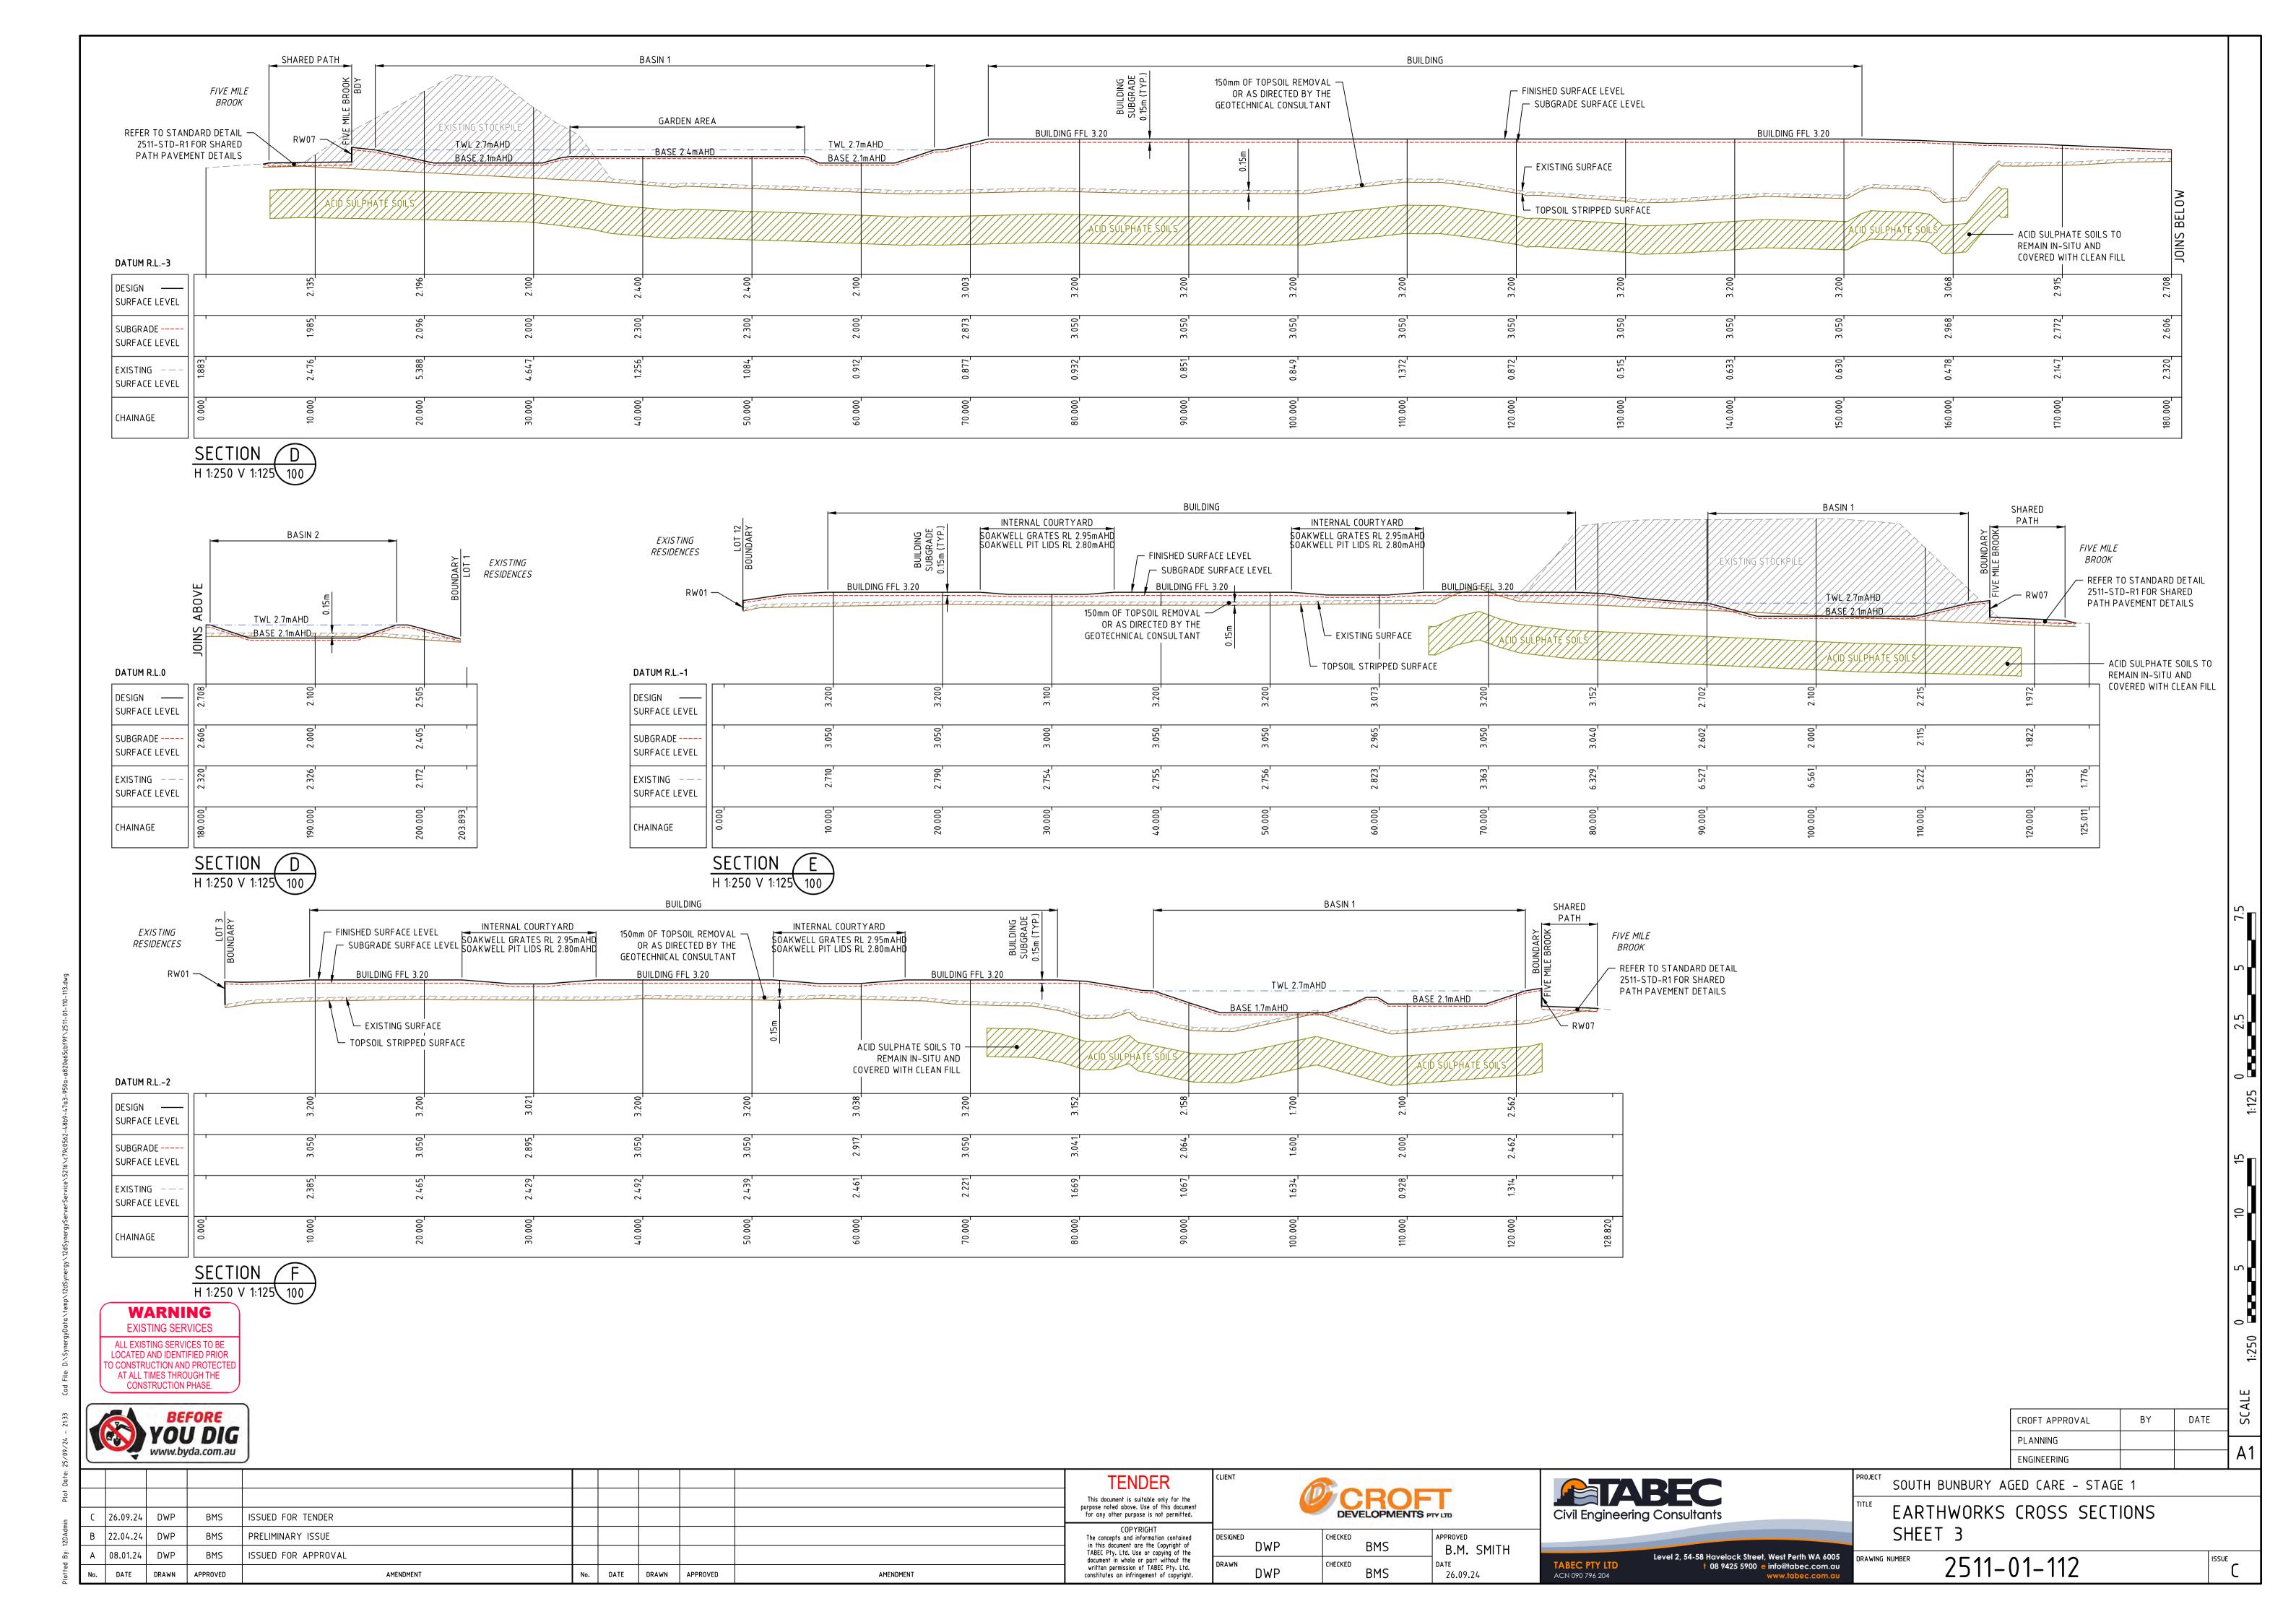



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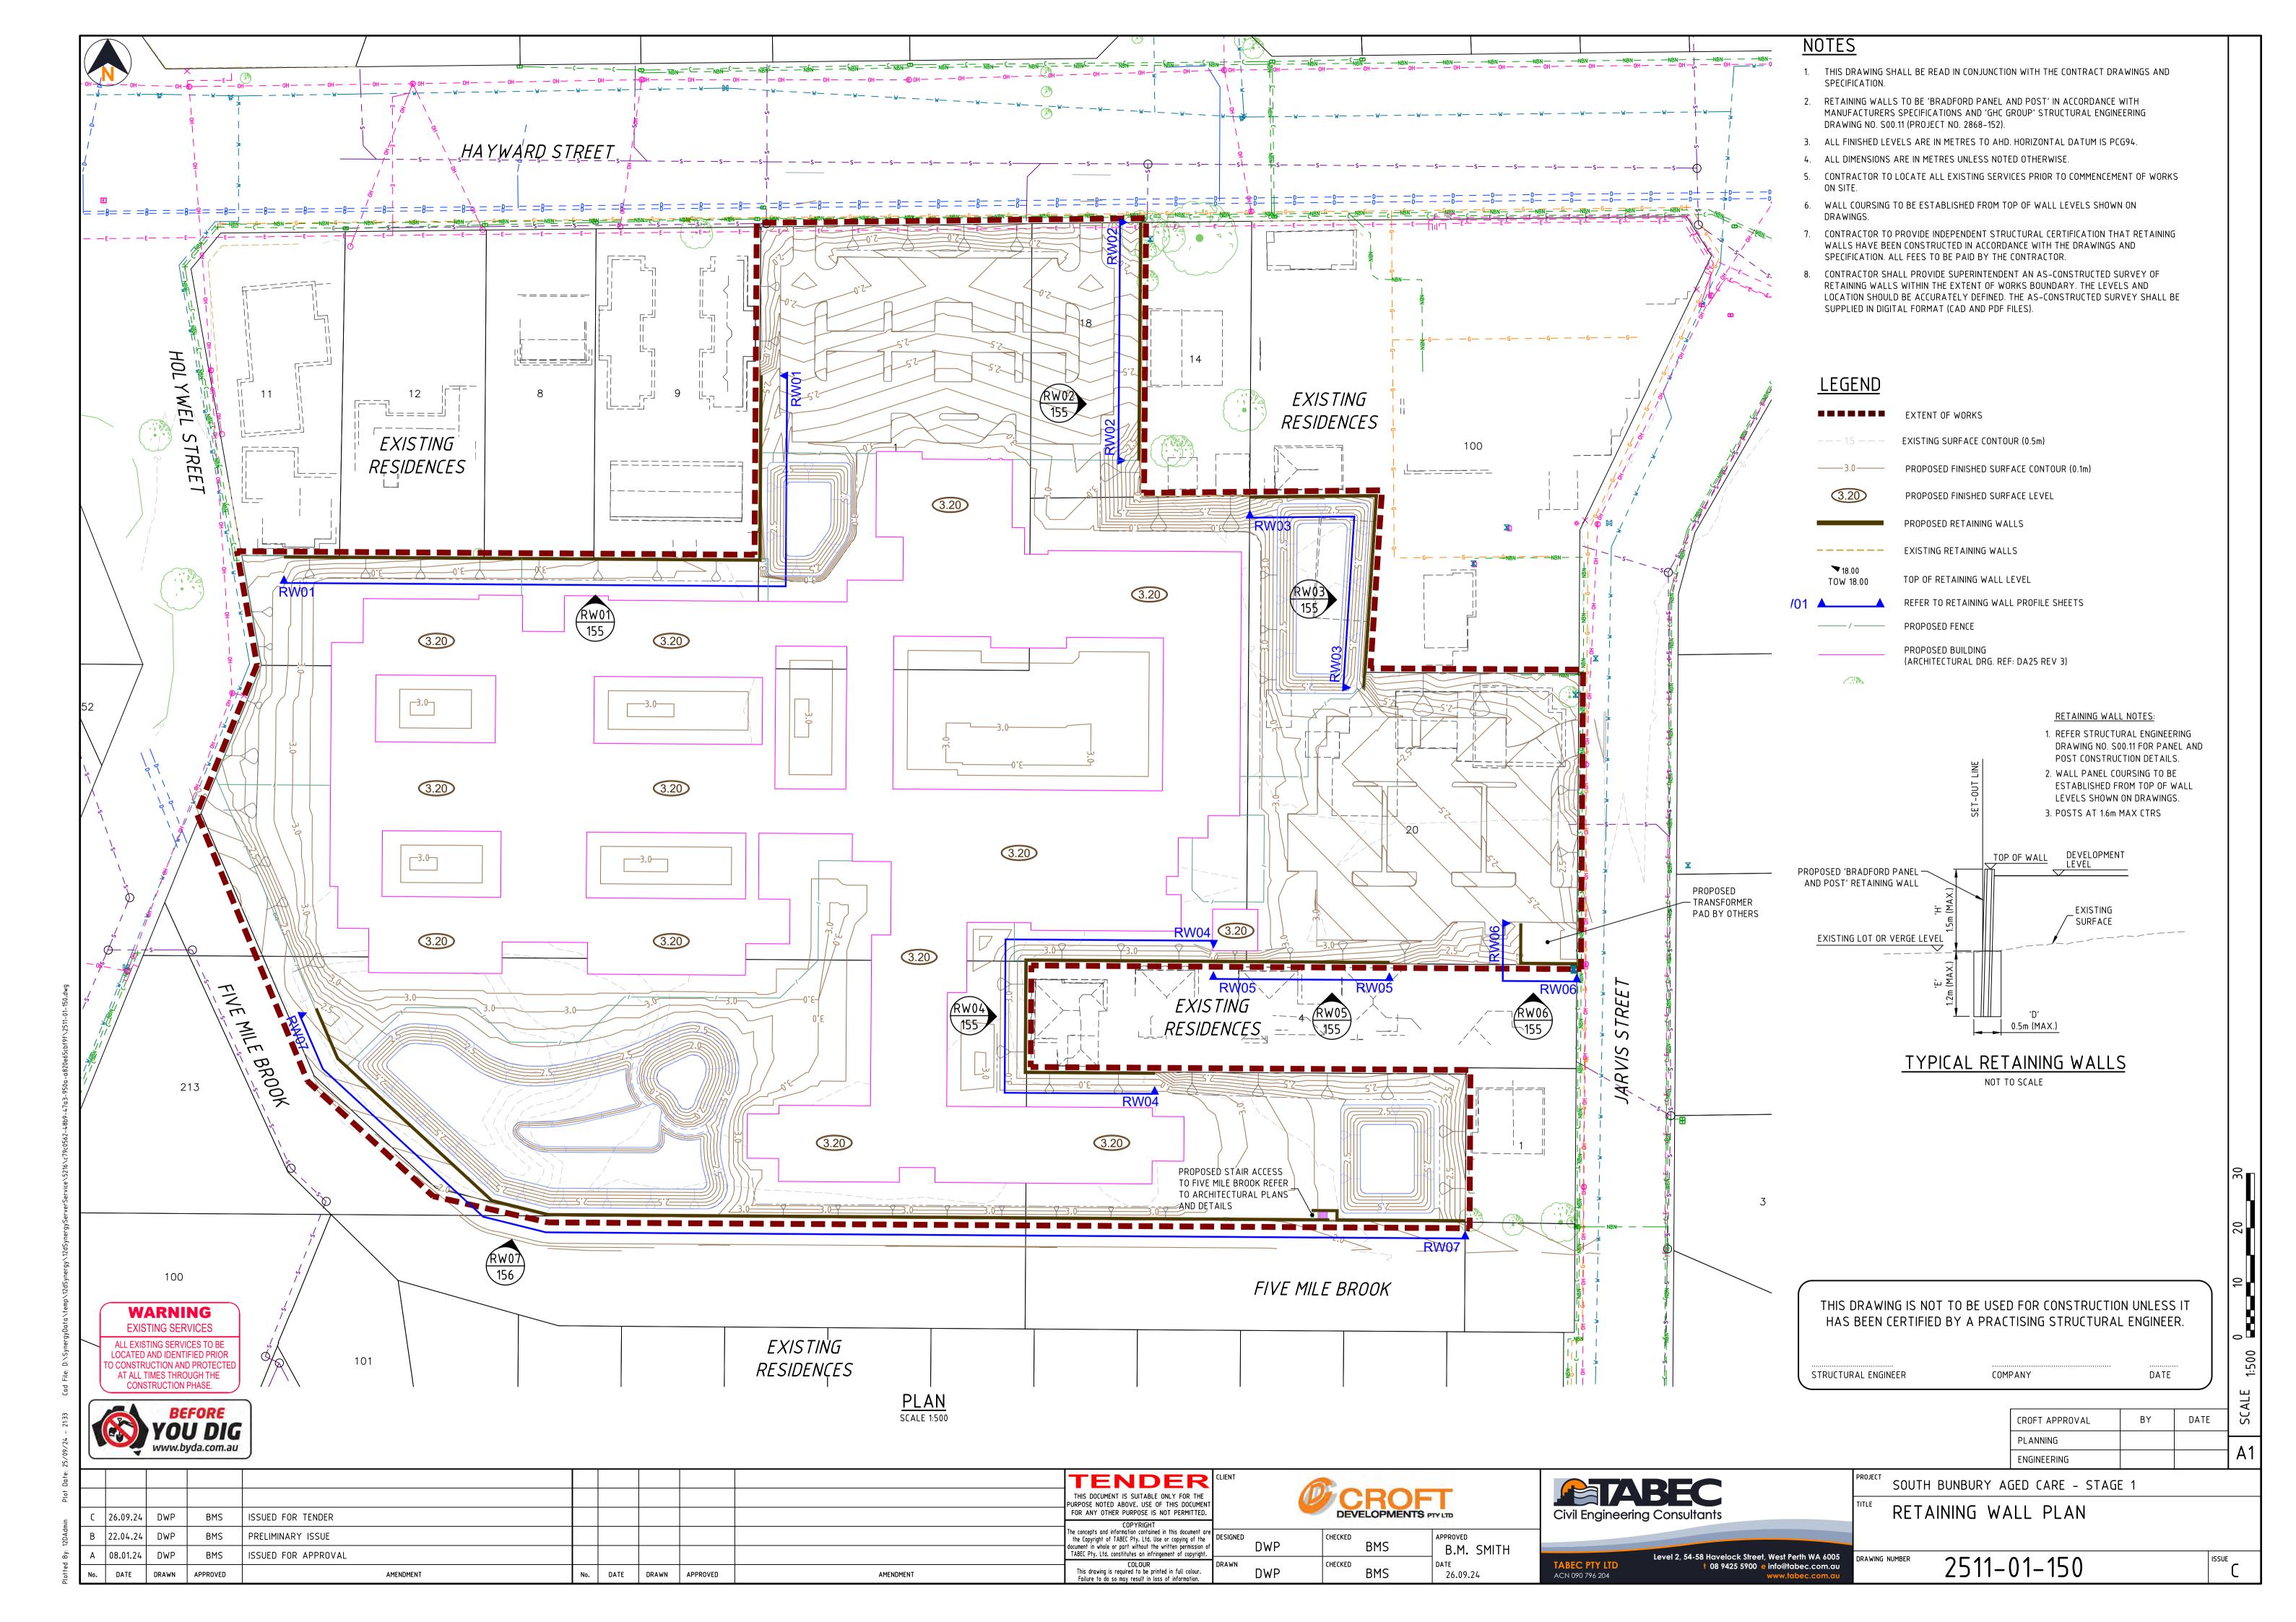
EARTHWORKS CROSS SECTIONS SHEET 2


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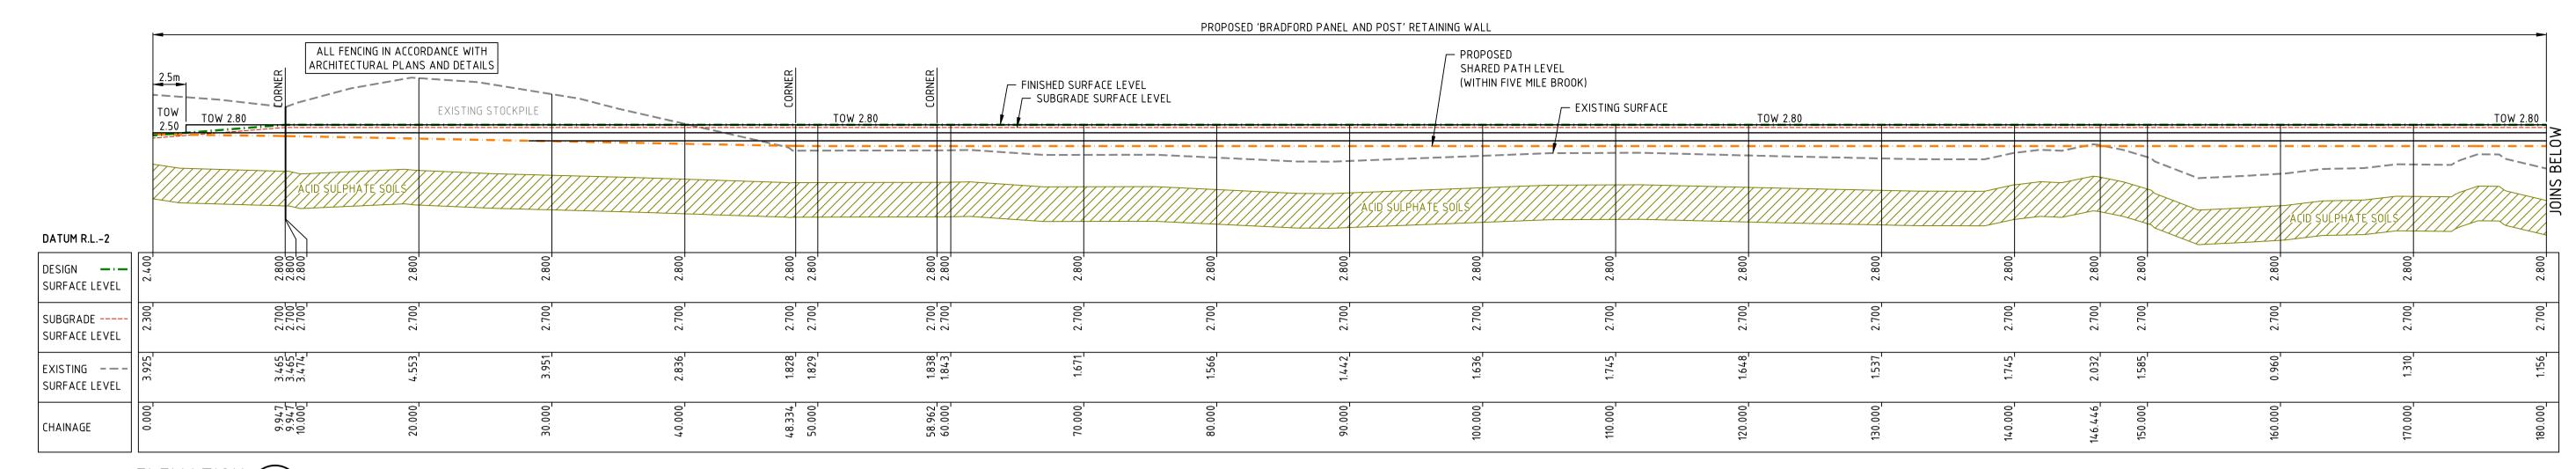






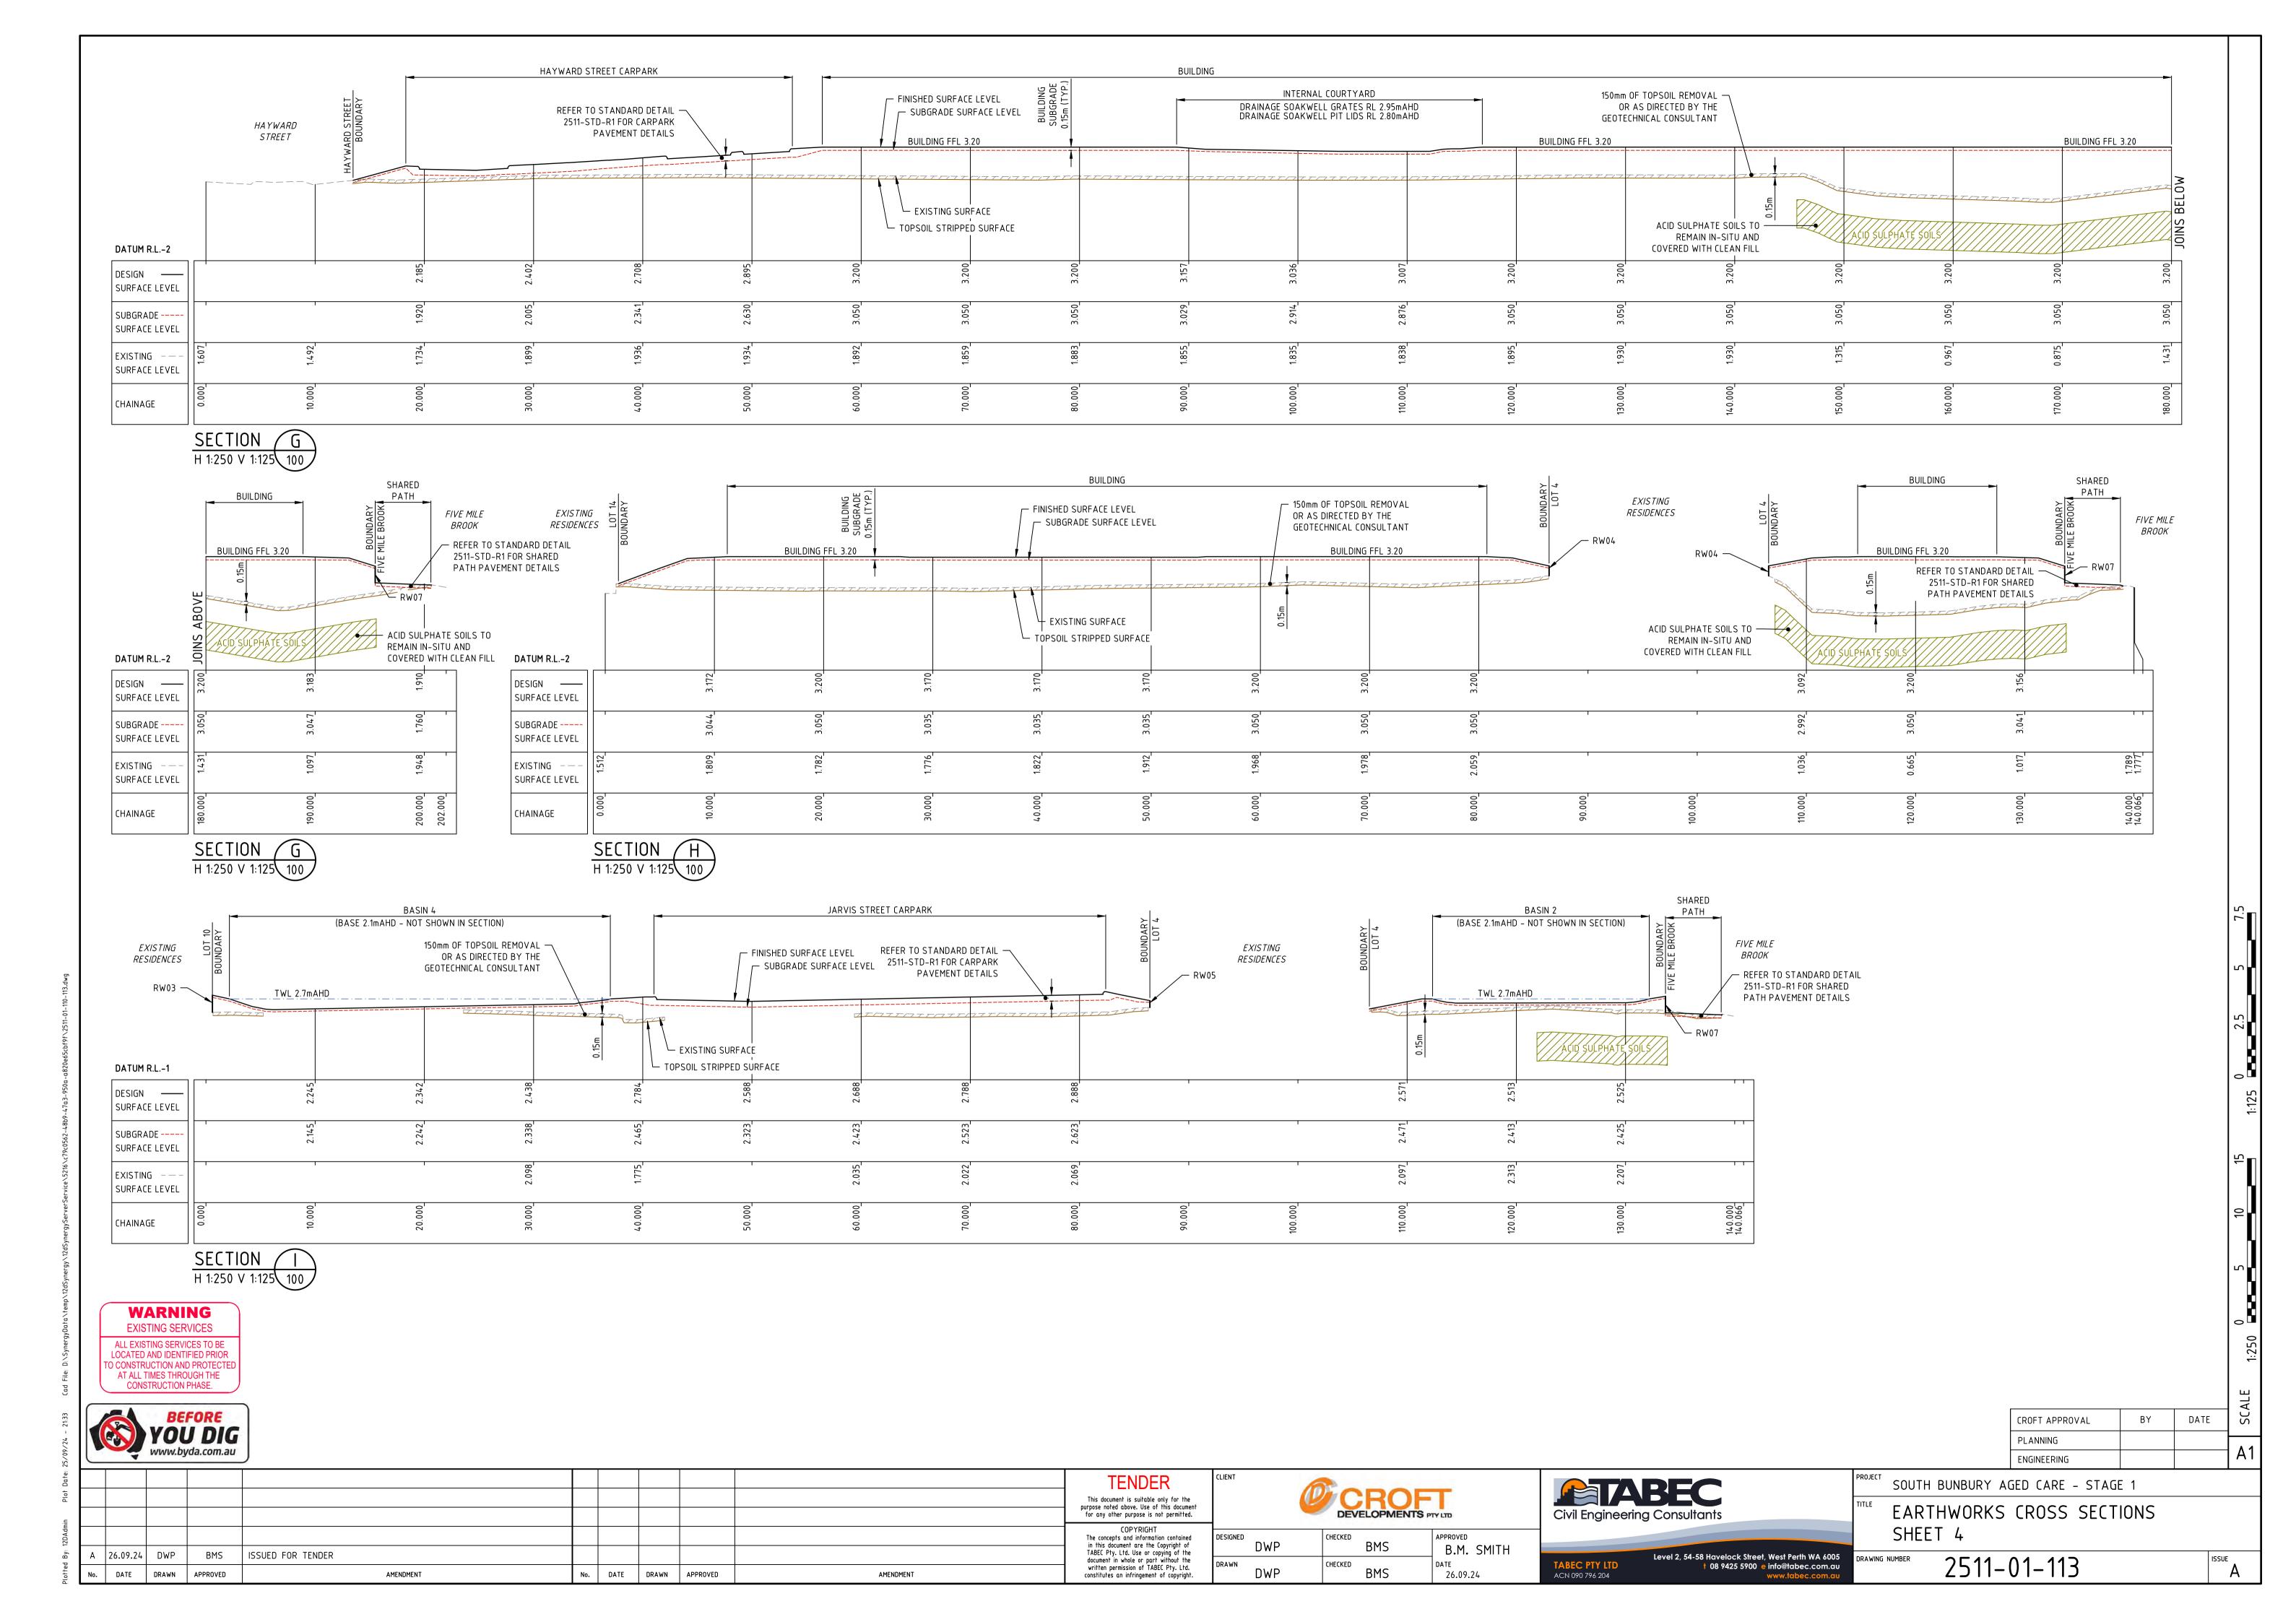

REFER STRUCTURAL ENGINEERING
DRAWING NO. S00.11 FOR PANEL
& POST CONSTRUCTION DETAILS

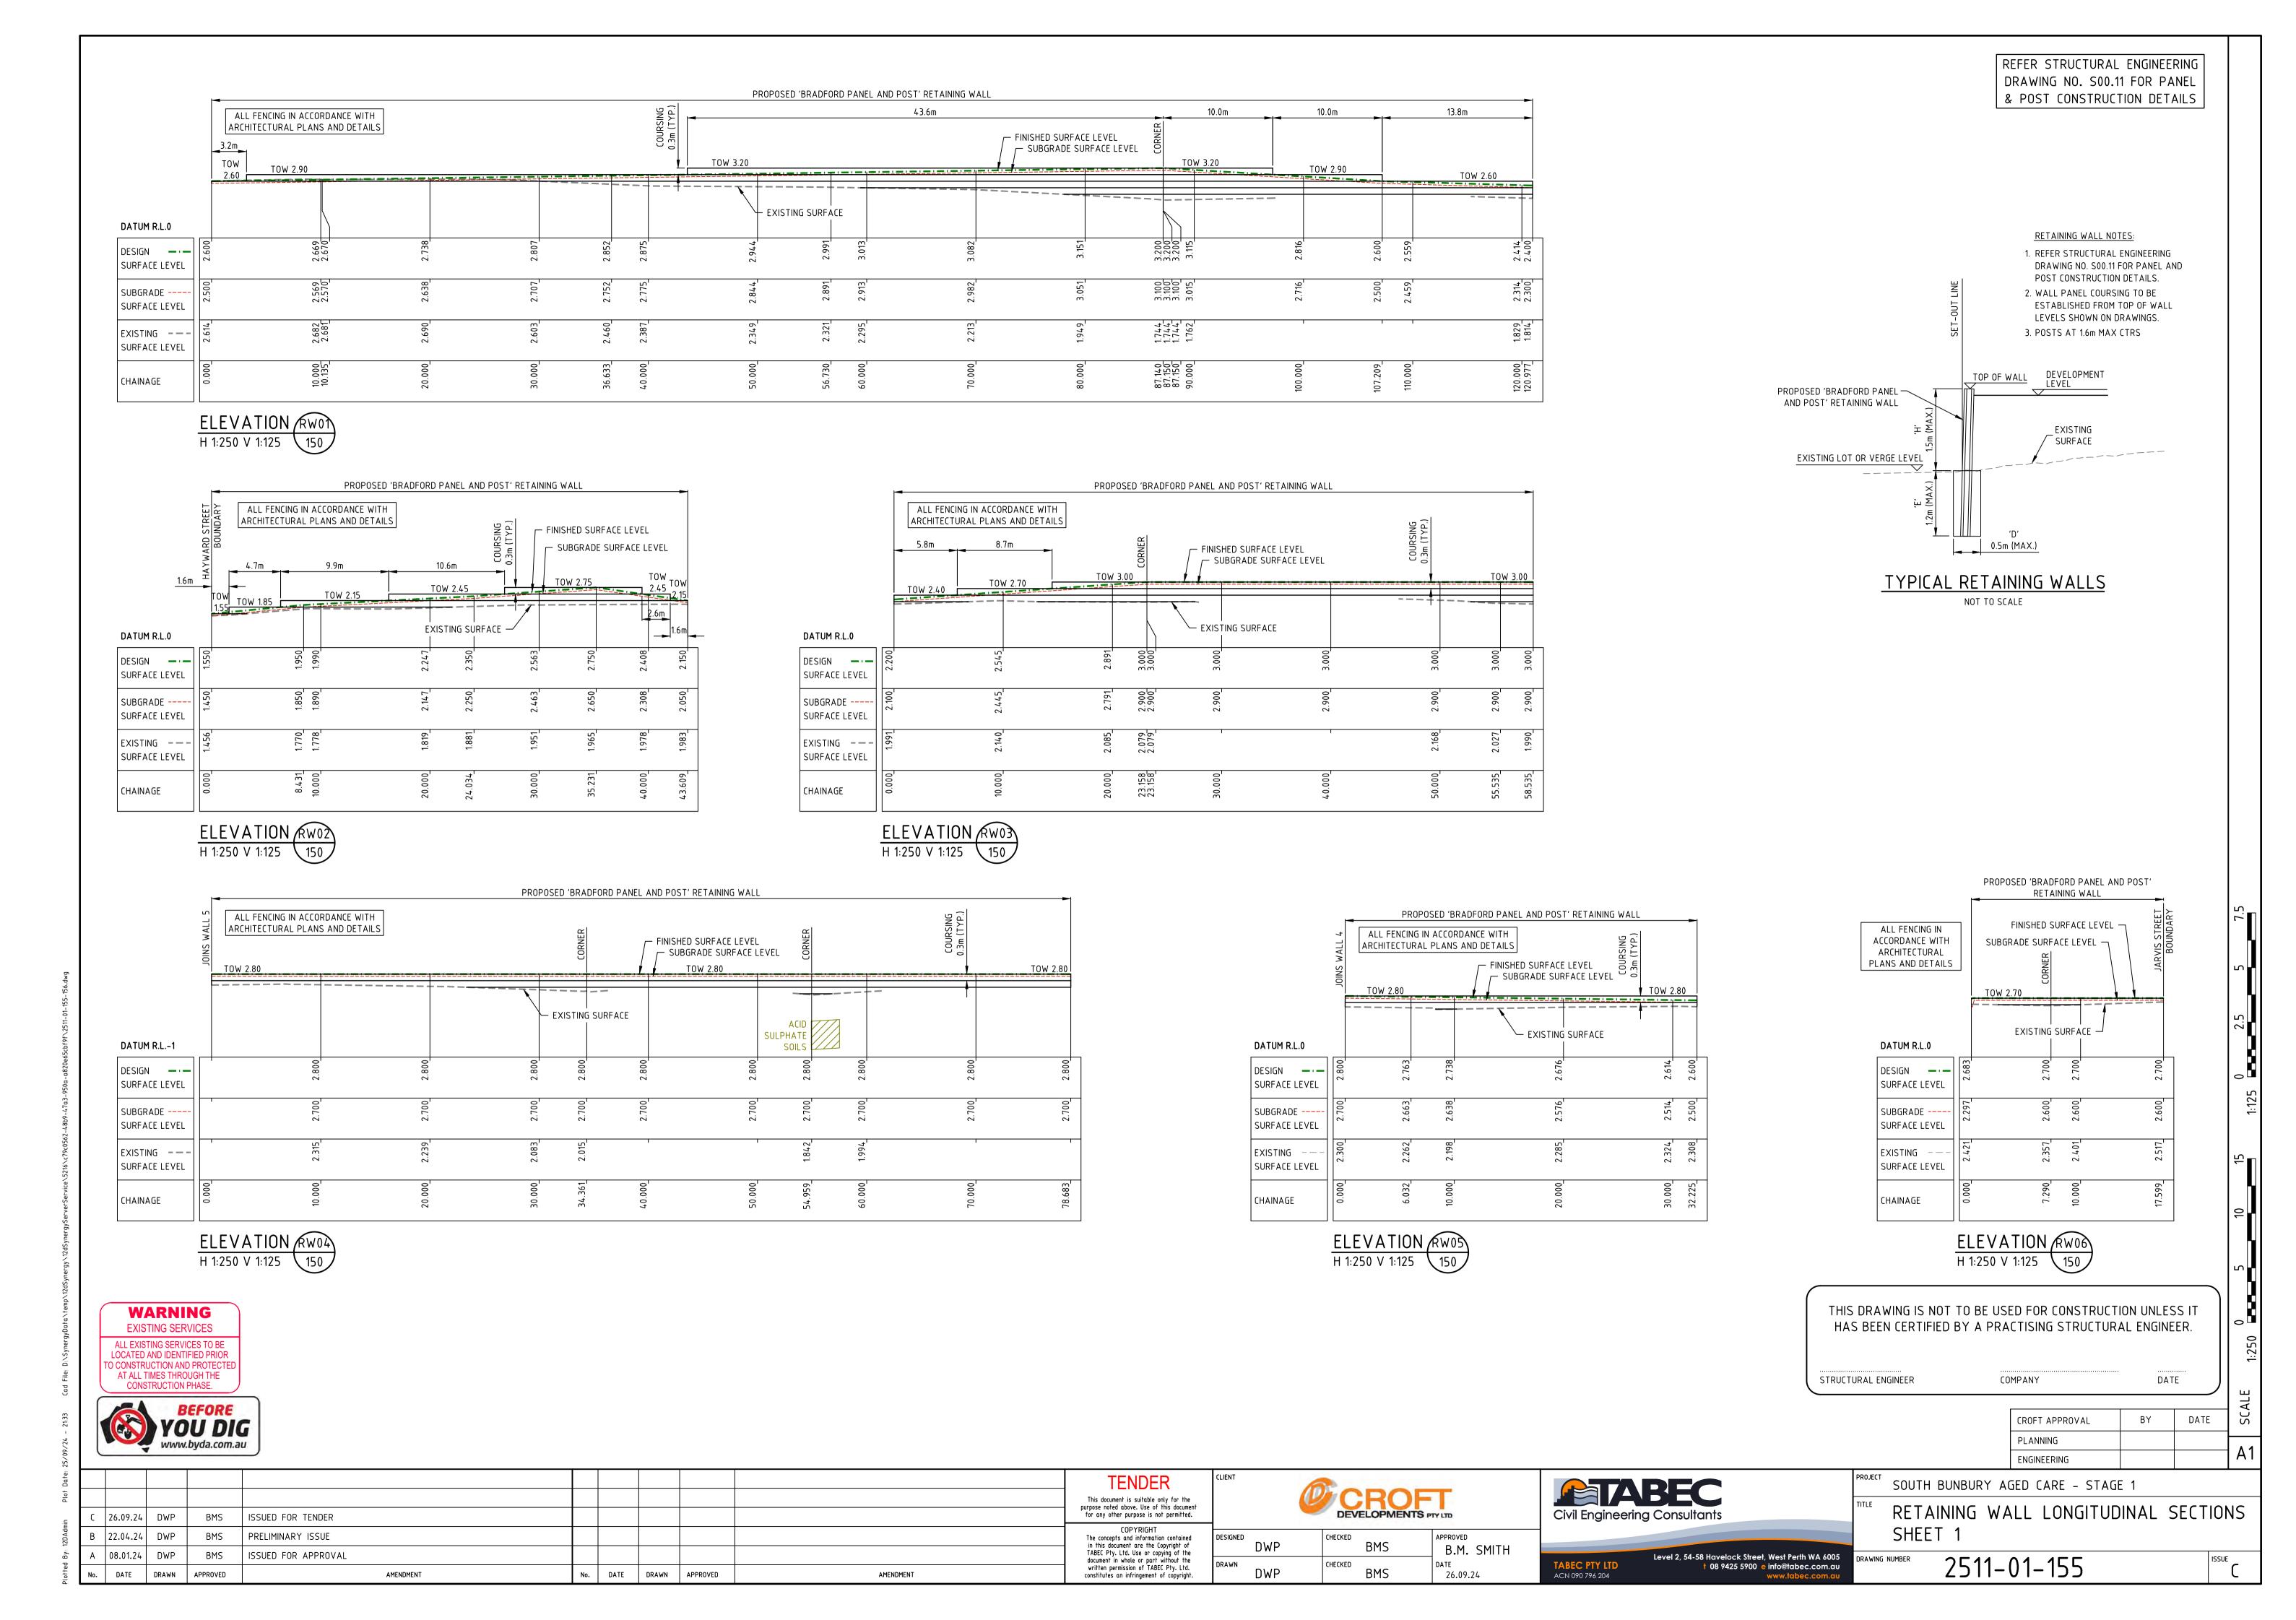

ELEVATION (RW07) H 1:250 V 1:125 150

PROPOSED 'BRADFORD PANEL AND POST' RETAINING WALL ALL FENCING IN ACCORDANCE WITH ARCHITECTURAL PLANS AND DETAILS STAIR - FINISHED SURFACE LEVEL - SUBGRADE SURFACE LEVEL — EXISTING SURFACE PROPOSED SHARED PATH LEVEL (WITHIN FIVE MILE BROOK) DATUM R.L.-2 DESIGN ---SURFACE LEVEL SUBGRADE --SURFACE LEVEL EXISTING ---SURFACE LEVEL CHAINAGE

> ELEVATION (RW07) H 1:250 V 1:125 (150)

PROPOSED 'BRADFORD PANEL AND POST' RETAINING WALL

PROPOSED 'BRADFORD PANEL AND POST' RETAINING WALL

EXISTING LOT OR VERGE LEVEL

1. REFER STRUCTURAL ENGINEERING DRAWING NO. S00.11 FOR PANEL AND POST CONSTRUCTION DETAILS.

2. WALL PANEL COURSING TO BE ESTABLISHED FROM TOP OF WALL LEVELS SHOWN ON DRAWINGS.

3. POSTS AT 1.6m MAX CTRS

TOP OF WALL

EXISTING

SURFACE

EXISTING

SURFACE

O.5m (MAX.)

TYPICAL RETAINING WALLS

NOT TO SCALE

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STRUCTURAL ENGINEER

COMPANY DATE

CROFT APPROVAL BY DATE

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RETAINING WALL LONGITUDINAL SECTIONS SHEET 2

DRAWING NUMBER 2511-01-156

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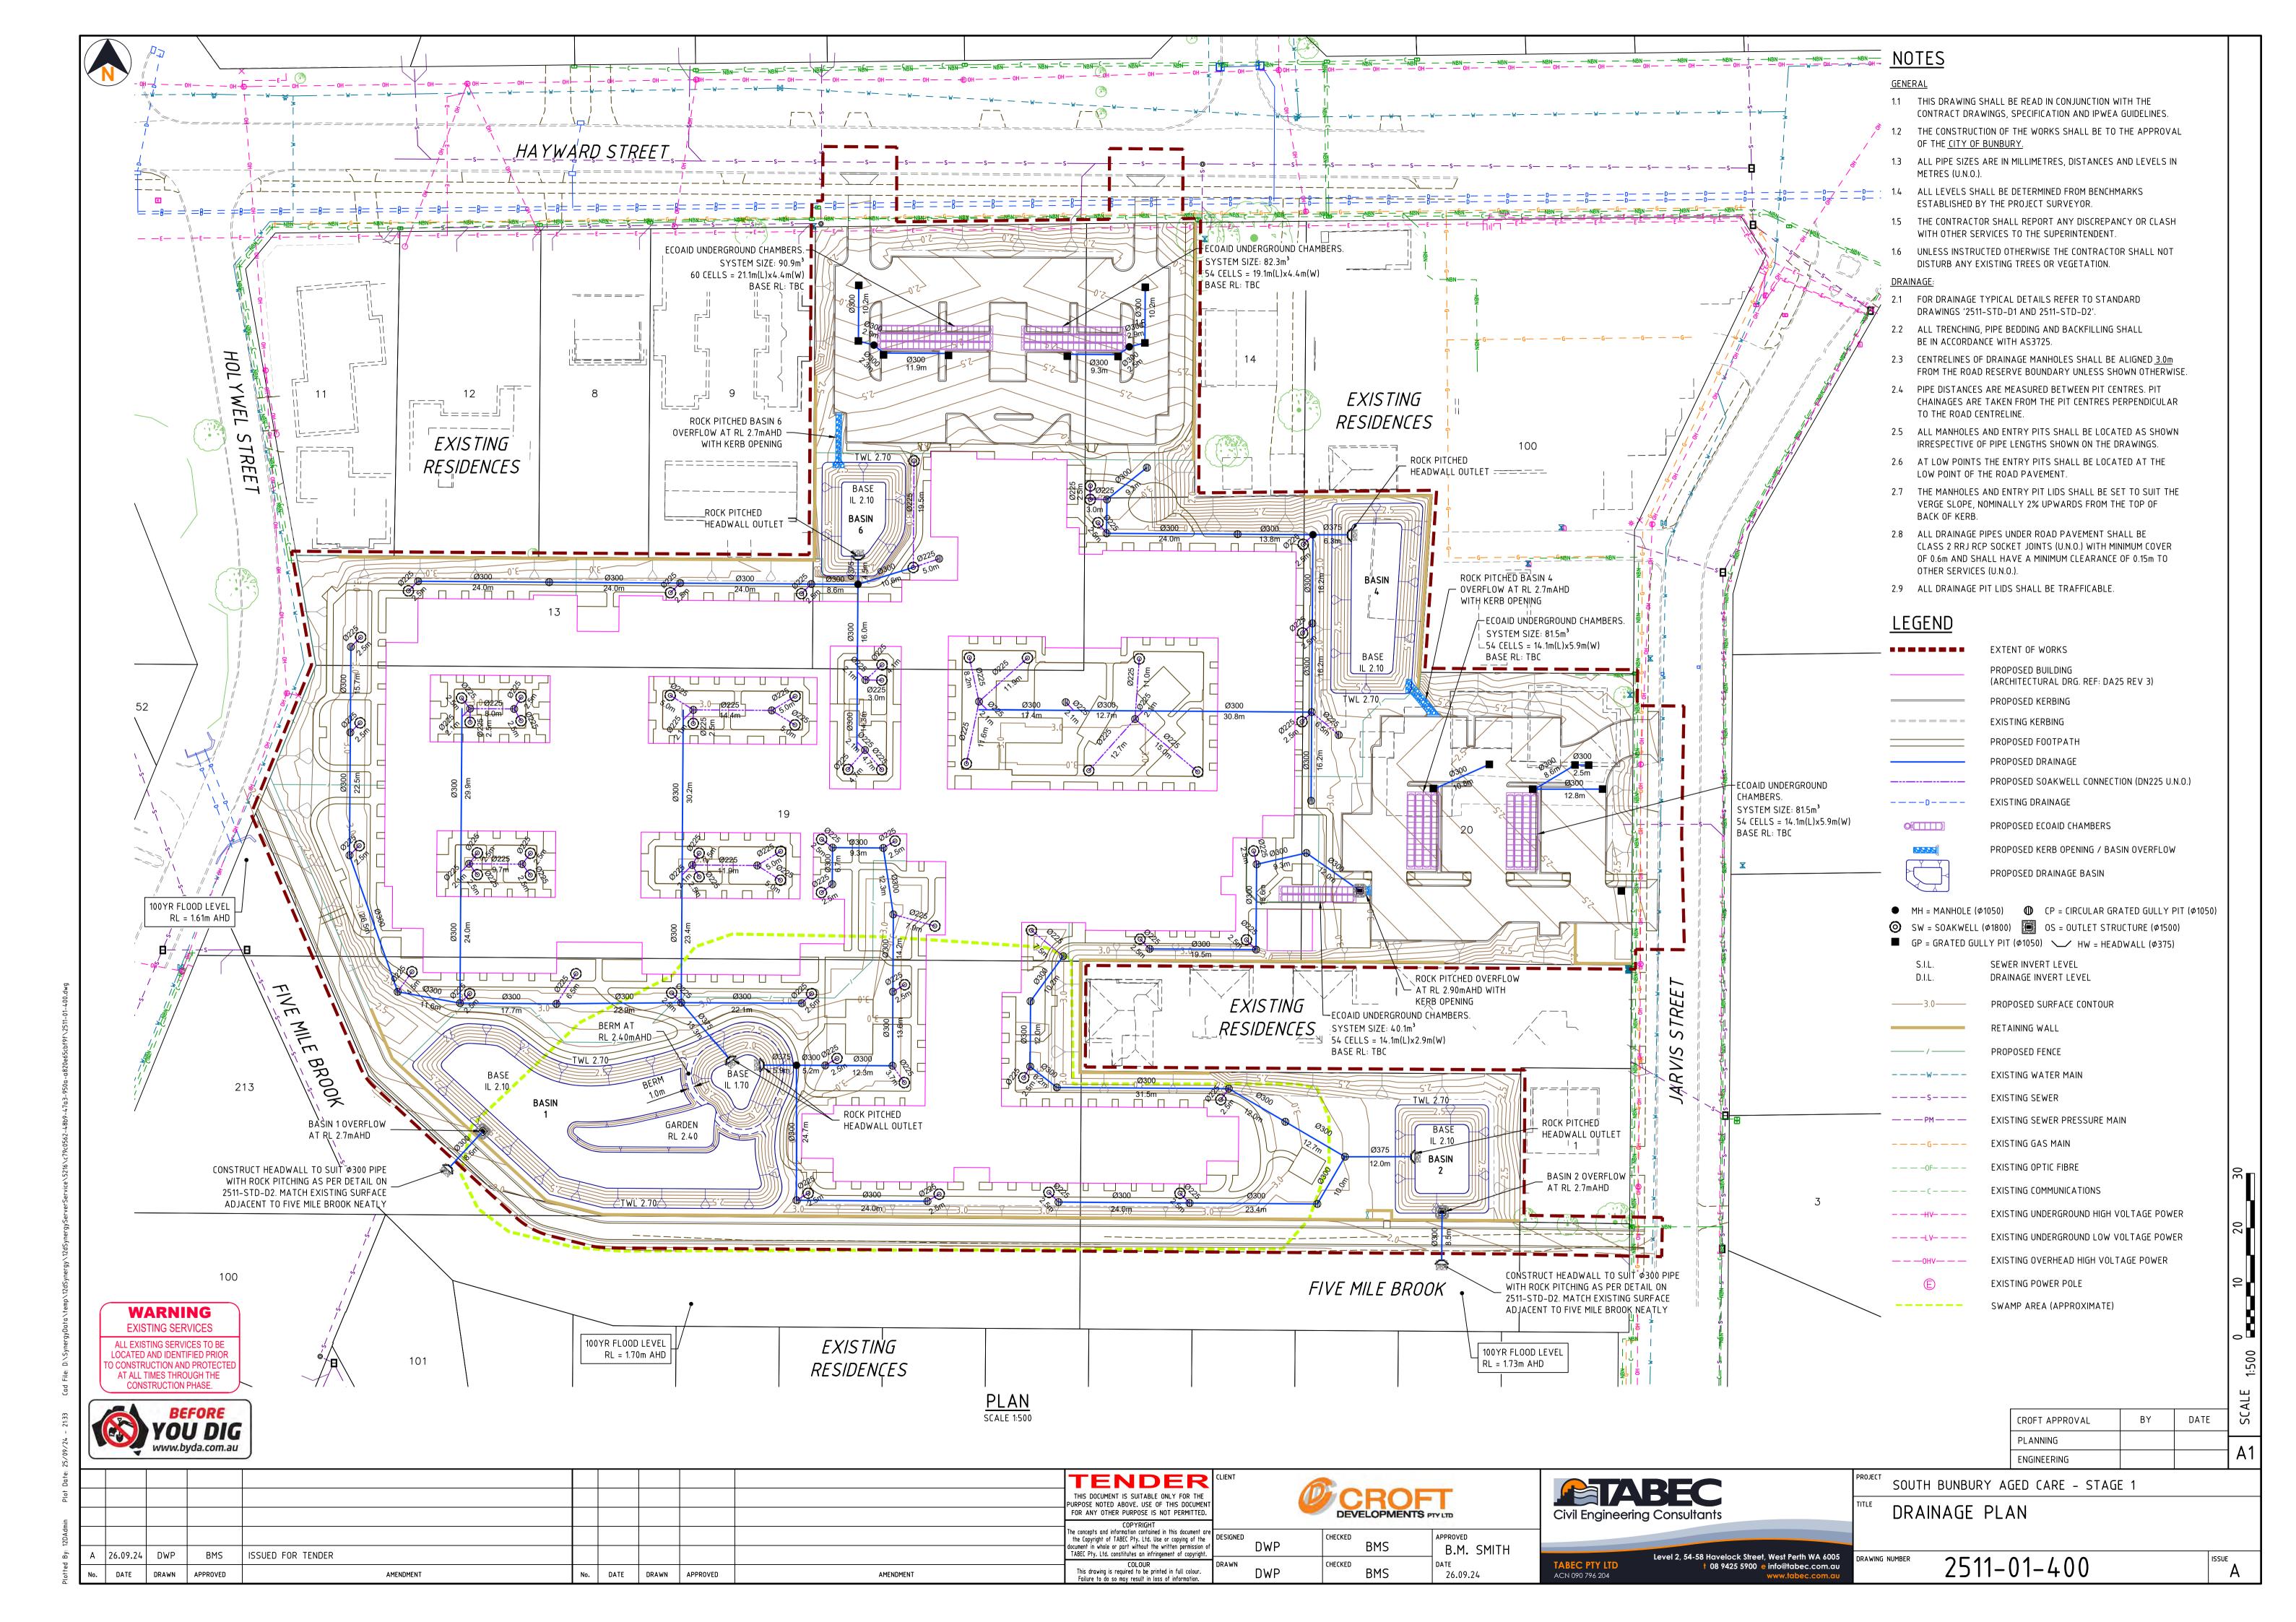
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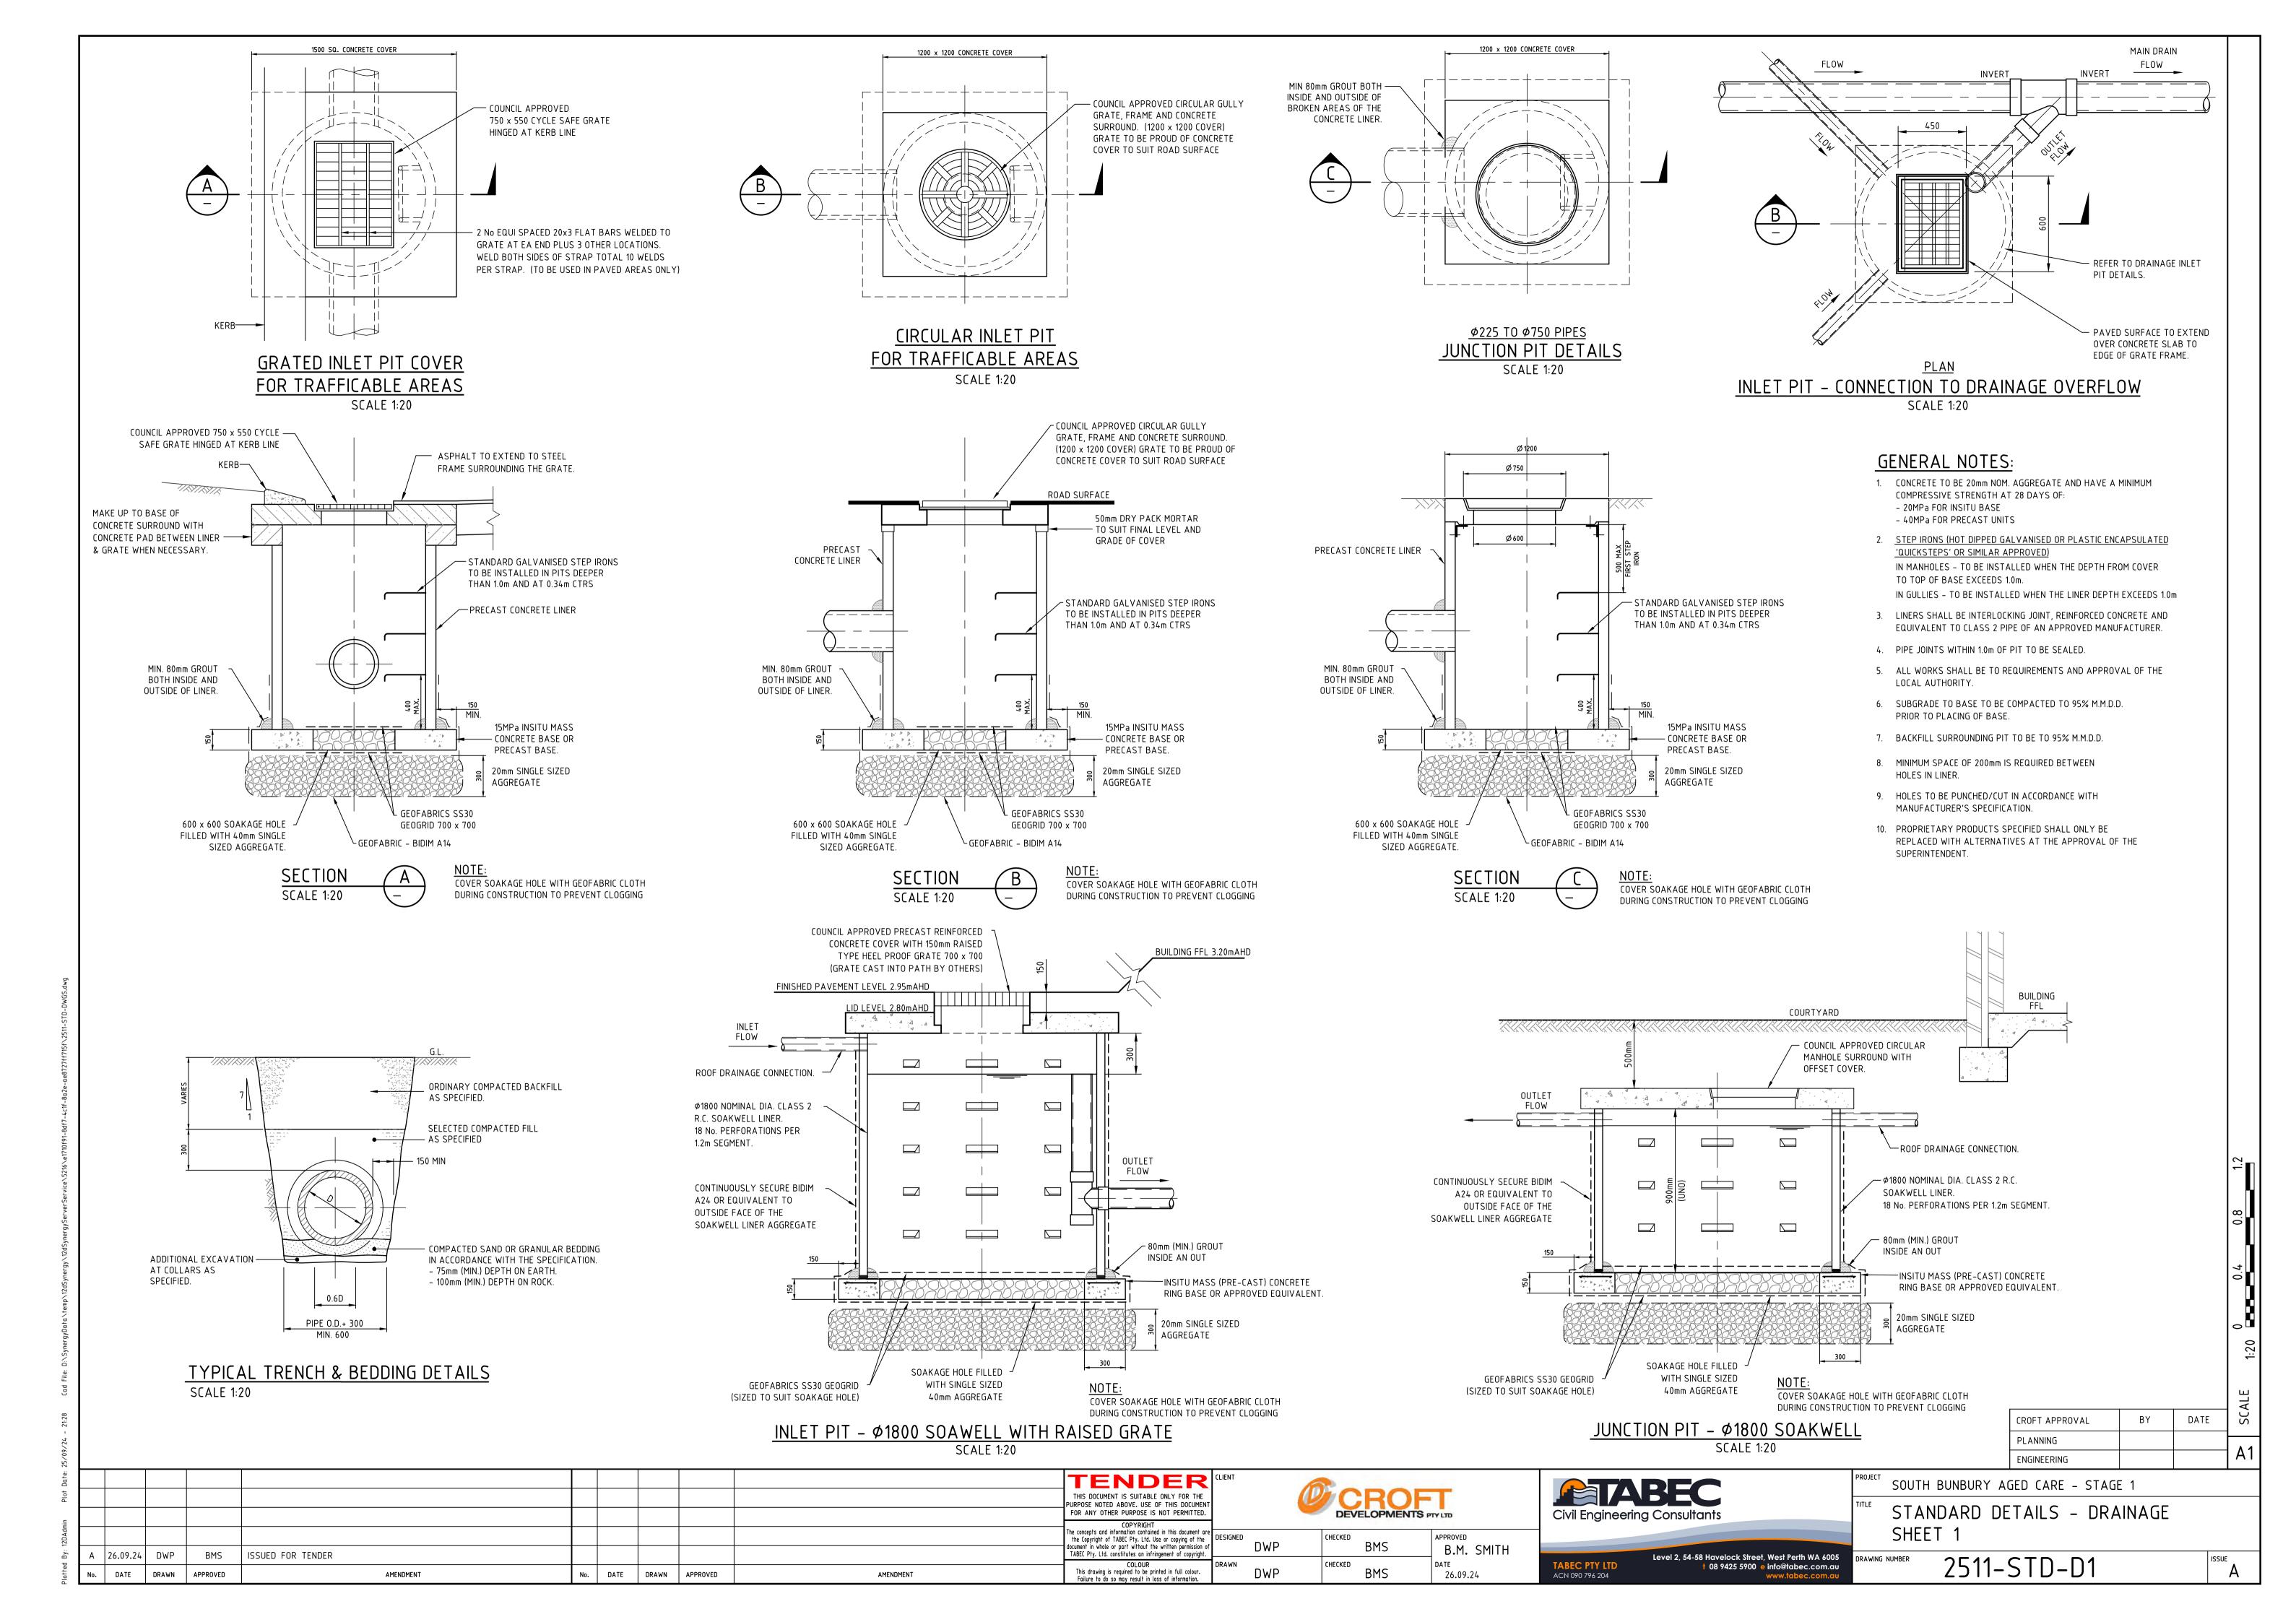
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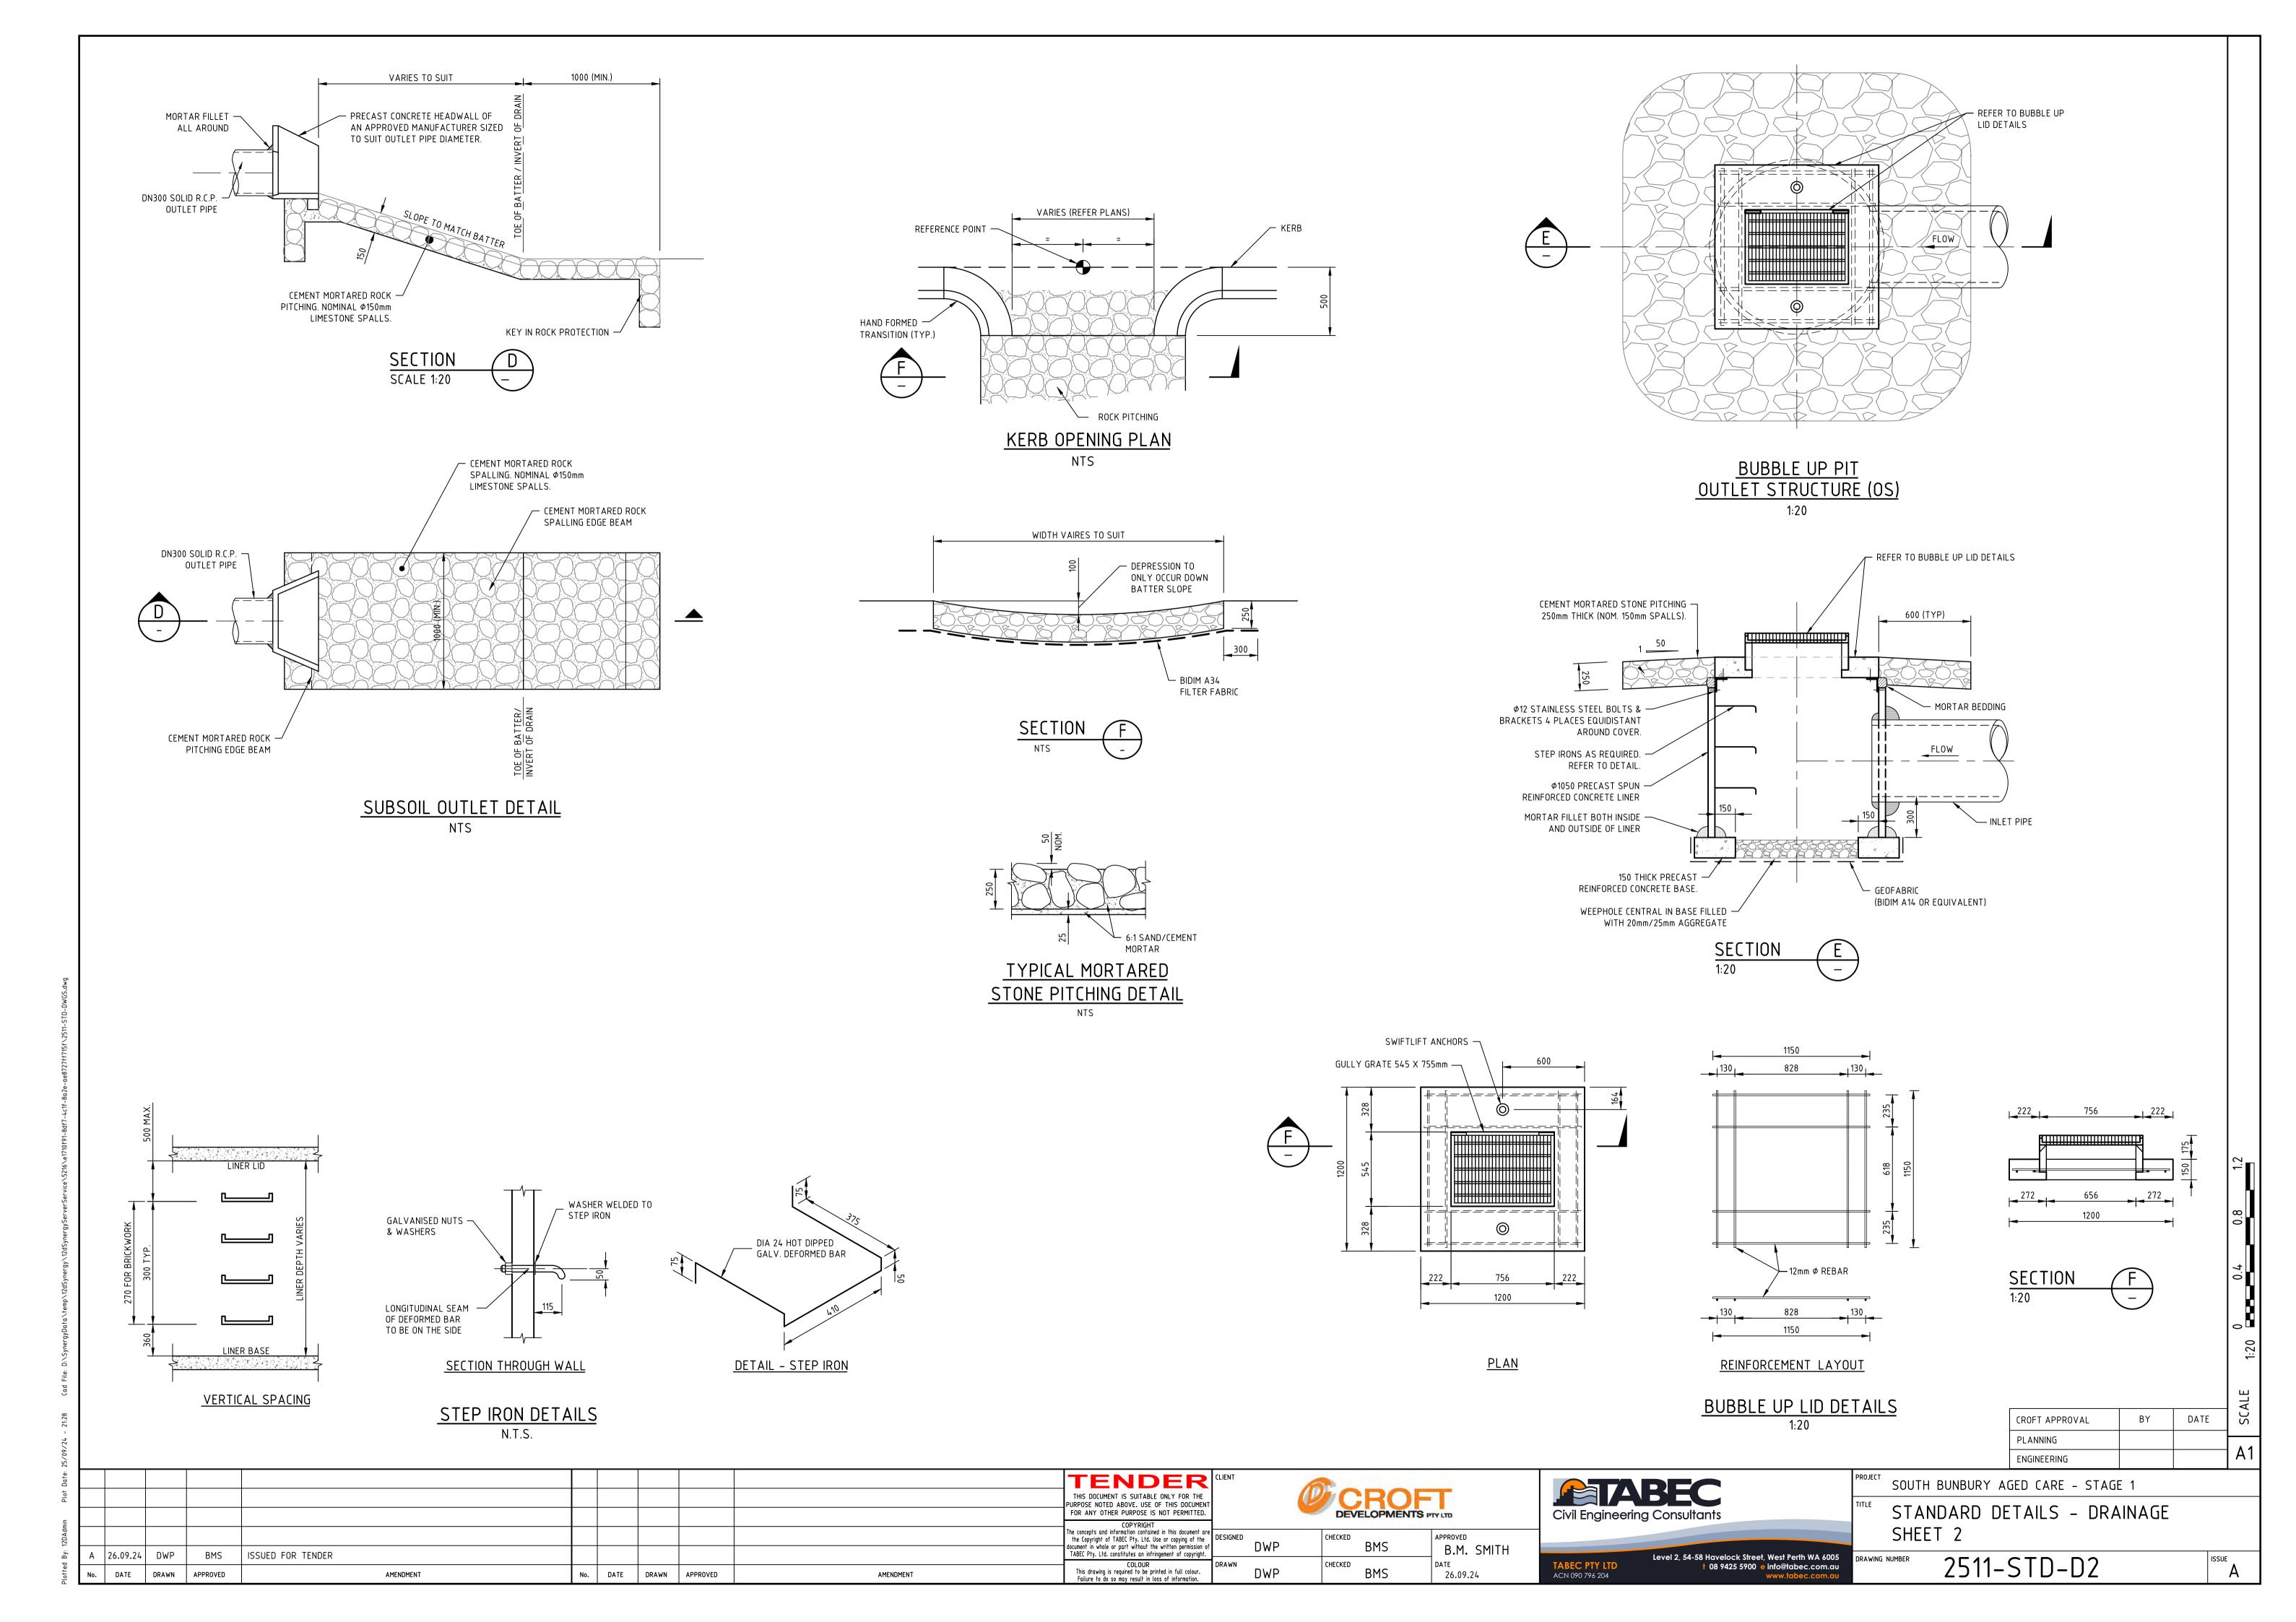
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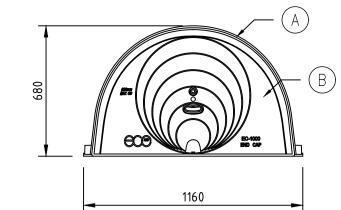


SUPPLIED SYSTEM COMPONENTS

A. EC-1000 Chamber


- B. EC-1000 End Cap C. Bidim A24 or A29, Nonwoven Geotextile
- D. Bidim A19, Nonwoven Geotextile, roll width
- E. Bontec SG40 or Mirafi 600X, Woven Geotextile, roll width 1.3m ×1, 3

- <u>LEGEND</u>
- Top of Finished Surface Level
 Granular, well-graded sub-base material
- 3. 20mm 50mm clean, crushed angular stone *2
- 4. Subgrade soil Approx. 1m x Ø150 PVC SN8 System equalising Connecting Pipes Cell Inlet pipe – RCP typically Pit, manhole or soakwell
- 8. Inspection Port *4
- 9. Typical Location for System Connecting Pipes *5
- ×1 Denotes refer to Notes for further info. ×5




STORAGE CELL NOTES:

- 1) Or equivalent approved by ecoAID. 2) See Manufacturers' drawing EC_002 entitled "EC-1000 System Specification" for detailed requirements.
- 3) Contractors to refer to EC-1000 Installation Guidelines for additional information on Catch-All inlet row set-up.
- 4) Recommended, when L > 25m with pit access one end, or L > 50m with access both ends. (See EC-1000 Inspection Port Detail Drawing.)
- 5) System Connecting Pipes to be installed 2nd Row In from beginning then Every 4th Row. Refer Drainage Plan for Layout.

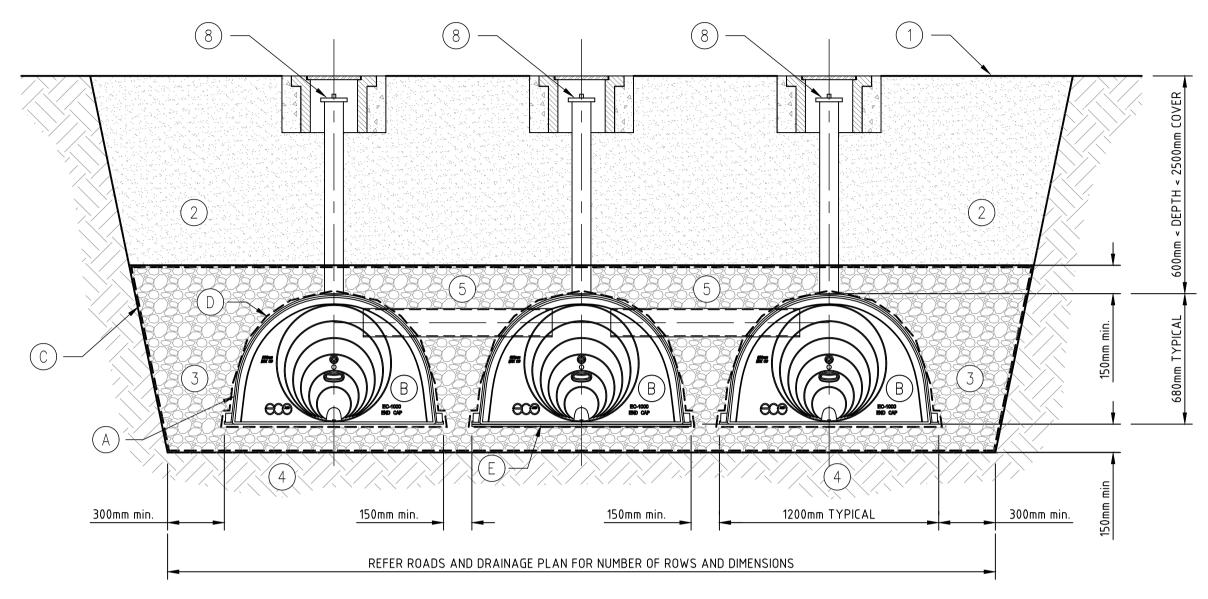

STORAGE CELL TYPICAL SECTION SCALE 1:20

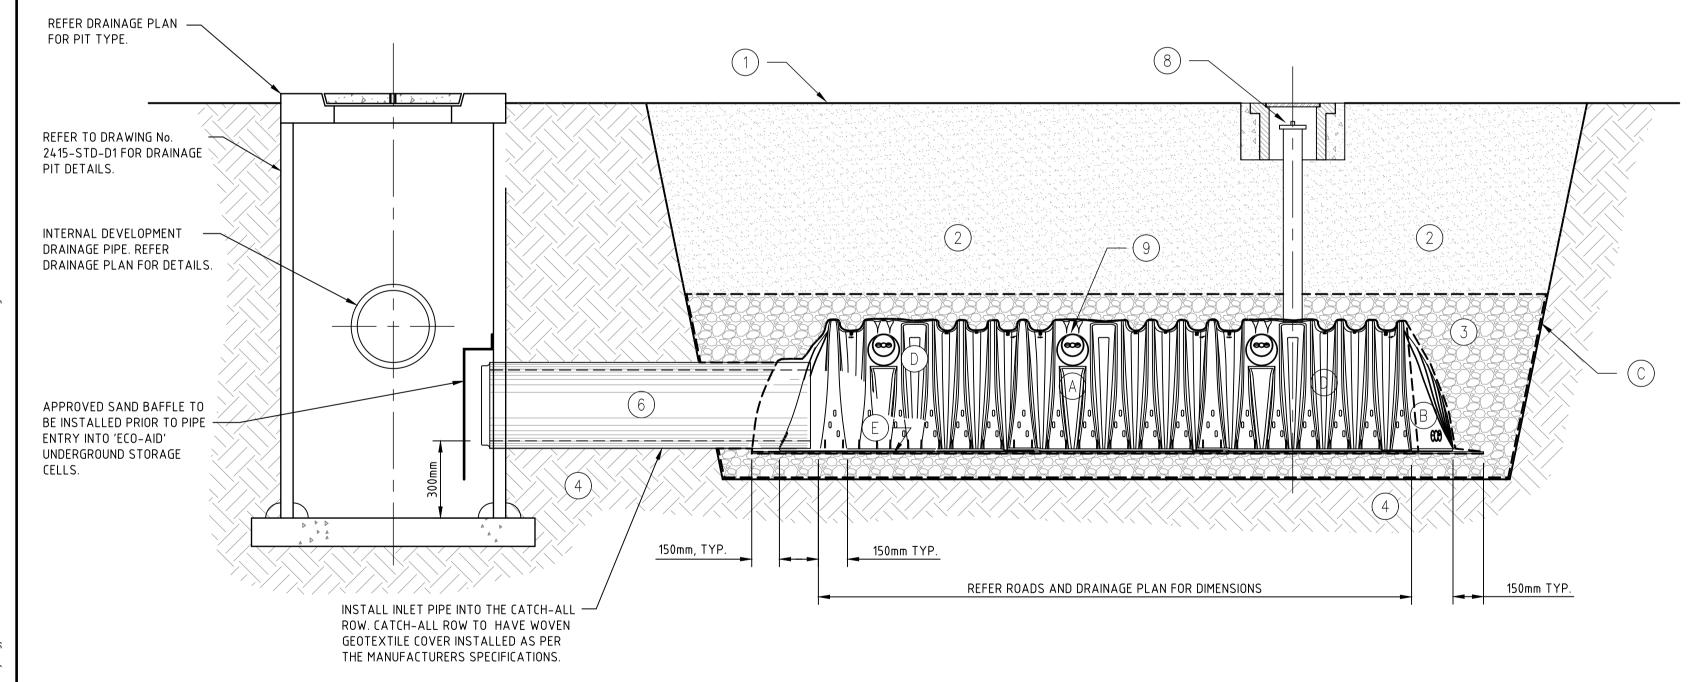

STORAGE CELL TYPICAL ELEVATION SCALE 1:20

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STANDARD DETAILS - DRAINAGE SHEET 3

2511-STD-D3